

PROJECT NAME AND LOCATION: MAIST ROAD APARTMENTS, DURHAM, NH 03824

DATE: 43°-08'-24.29"N, 70°-57'-10.75"W

DESCRIPTION: THE PROPOSED PROJECT CONSISTS OF THE CONSTRUCTION OF A MULTI-UNIT HOUSING DEVELOPMENT WITH ASSOCIATED SITE IMPROVEMENTS...

SOIL CHARACTERISTICS: SOILS FOUND ON THE SITE SPECIFIC SOIL SURVEY CONDUCTED BY STONEY RIDGE ENVIRONMENTAL, LLC...

- 1. CUT AND CLEAR: REMOVE ALL VEGETATION AND OBSTRUCTIONS... 2. CONSTRUCT TEMPORARY AND PERMANENT SEDIMENT, EROSION AND DETENTION CONTROL FACILITIES...

NAME OF RECEIVING WATERS: STORMWATER RUNOFF IS COLLECTED, TREATED AND DETAINED BY A CLOSED DRAINAGE SYSTEM...

- 1. TEMPORARY SEEDING: MULCH SHALL BE APPLIED AT A RATE OF BETWEEN 1.5 TO 2 TONS PER ACRE... 2. MULCHING: MULCH SHALL BE APPLIED AT A RATE OF BETWEEN 1.5 TO 2 TONS PER ACRE...

- 1. SEEDING: UTILIZE ANNUAL RYE GRASS AT A RATE OF 40 LBS/ACRE... 2. MAINTENANCE: TEMPORARY SEEDINGS SHALL BE PERIODICALLY INSPECTED...

OFF-SITE VEHICLE TRACKING: CONTRACTOR SHALL CONSTRUCT THE STABILIZED CONSTRUCTION ENTRANCE(S) PRIOR TO ANY EXCAVATION ACTIVITIES.

INSTALLATION, MAINTENANCE AND INSPECTION PROCEDURES OF EROSION AND SEDIMENT CONTROLS:

- 1. ALL SWALES SHALL BE STABILIZED PRIOR TO DIRECTING FLOW TO THEM... 2. THE SMALLEST PRACTICAL SITE WILL BE DENOTED AT ONE TIME UNDER NO CIRCUMSTANCES SHALL MORE THAN 5.0 ACRES OF THE PROJECT SITE BE UNSTABILIZED AT ONE TIME...

PHYSICAL PROPERTY TEST REQUIREMENTS: FILTERING EFFICIENCY: 75% MINIMUM, TENSILE STRENGTH AT 20% MAXIMUM ELONGATION: 50 LB/LINEAR IN (MIN.)

CONCRETE WASHOUT AREAS: CONTRACTOR SHOULD BE ENCOURAGED WHERE POSSIBLE, TO USE WASHOUT FACILITIES AT THEIR OWN PLANT OR DISPATCH FACILITY.

ALLOWABLE NON-RESIDUAL DISCHARGES: FIRE HYDRANT FLUSHINGS, WATER USED TO WASH VEHICLES WHERE DETERGENTS ARE NOT USED...

BLASTING BEST MANAGEMENT PRACTICES (BMP): CONTRACTOR SHALL BE RESPONSIBLE TO CONTROL DUST THROUGHOUT THE CONSTRUCTION PERIOD...

- 1. SILT FENCE: SYNTHETIC FILTER FABRIC SHALL BE A PREVIOUS SHEET OF PROPYLENE, NYLON, POLYESTER OR ETHYLENE YARN AND SHALL BE ORDERED FROM THE MANUFACTURER OR SUPPLIER AS CONFORMING TO THE FOLLOWING REQUIREMENTS...

- 1. FILTREX SILT SOXX: FILTREX SILT SOXX ARE TO BE INSTALLED DOWN SLOPE OF ANY DISTURBED AREA REQUIRING EROSION AND SEDIMENT CONTROL... 2. SILT SOXX USED FOR PERIMETER CONTROL OF SEDIMENT AND SOLUBLE POLLUTANTS IN STORM RUNOFF SHALL MEET FILTREX SOXX MATERIAL SPECIFICATIONS...

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- 1. BLACK AND GRAVEL INLET PROTECTION: ALL CONCRETE BLOCKS LENGTHWISE ON THEIR SIDE IN A SINGLE ROW AROUND THE PERIMETER OF THE INLET, WITH THE ENDS OF ADJACENT BLOCKS ABUTTING... 2. MAINTENANCE: THE ENTRANCE SHALL BE MAINTAINED IN A CONDITION WHICH WILL PREVENT TRACKING OF SEDIMENT INTO THE DRIVEWAY...

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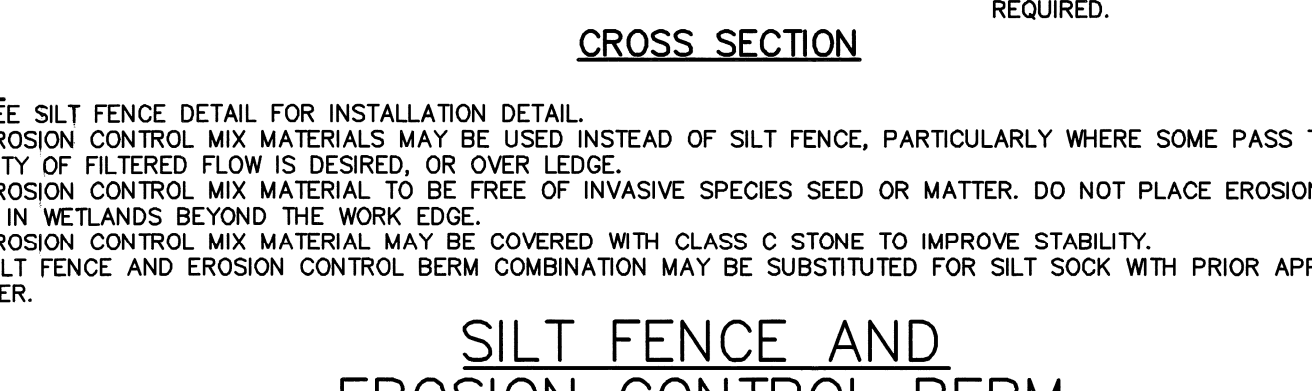
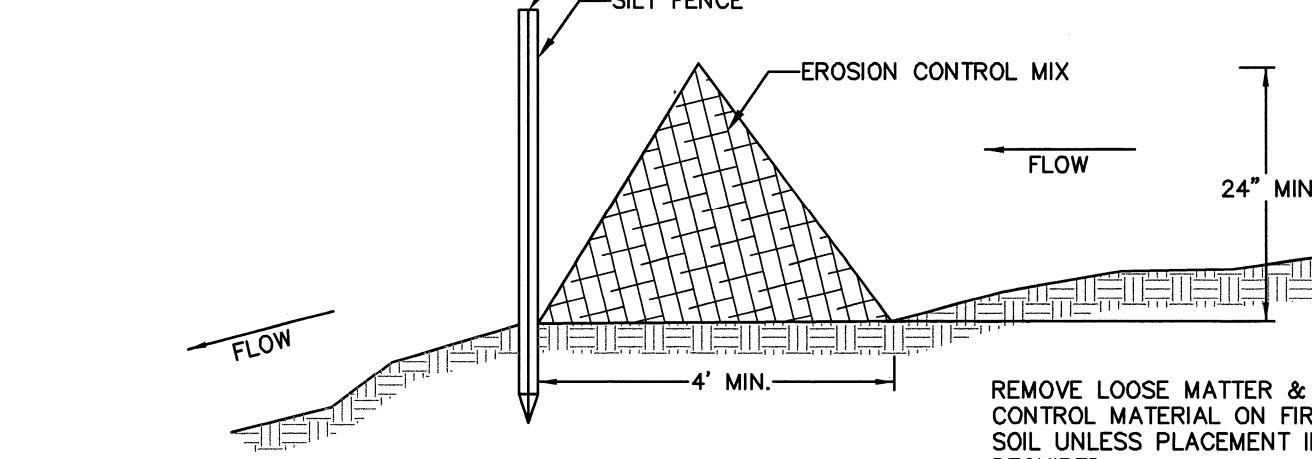
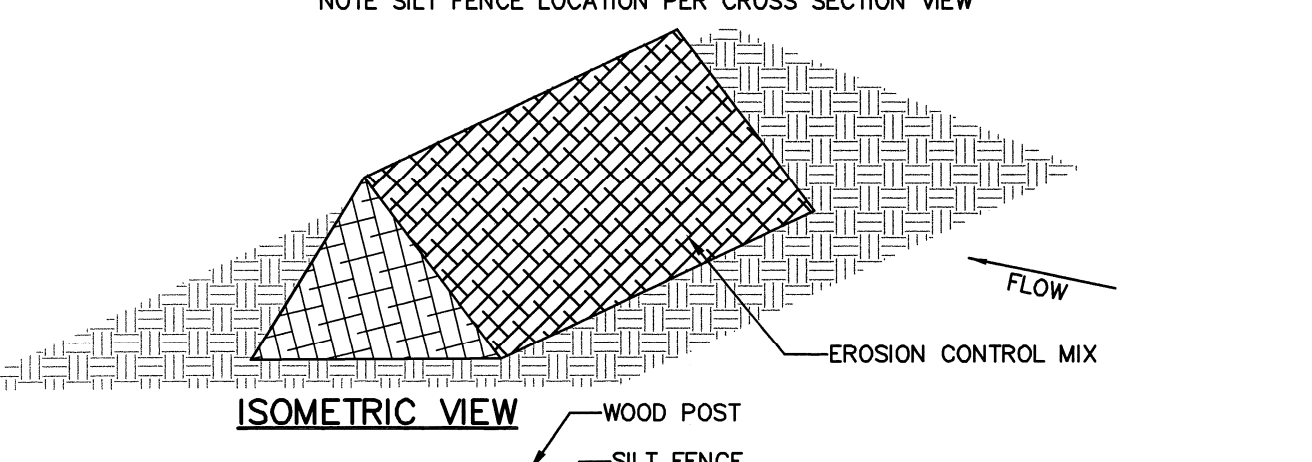
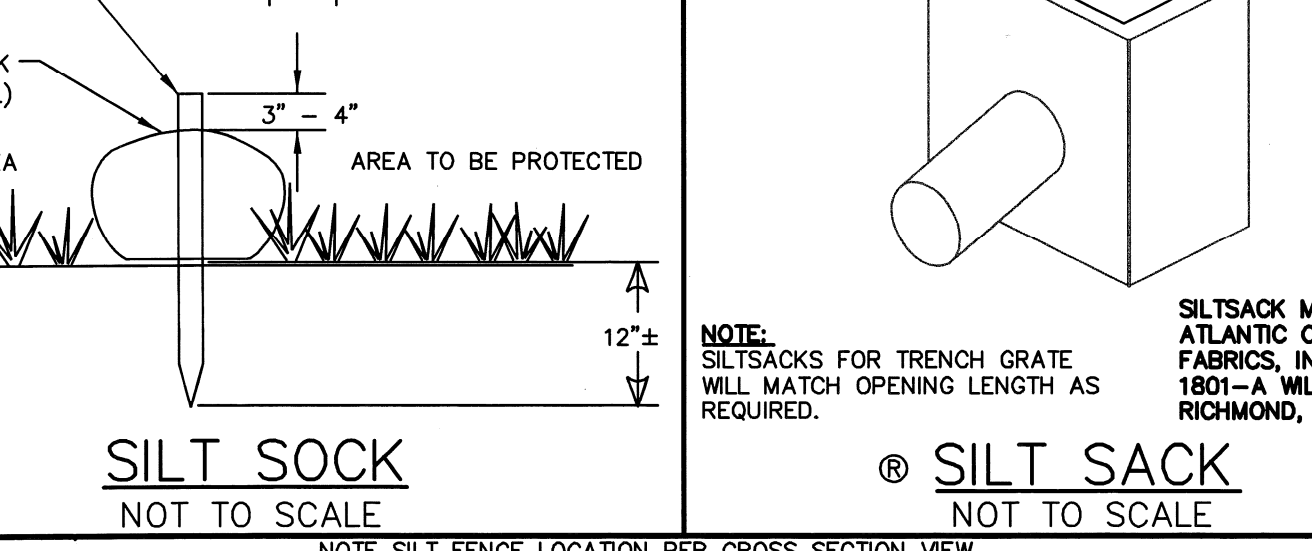
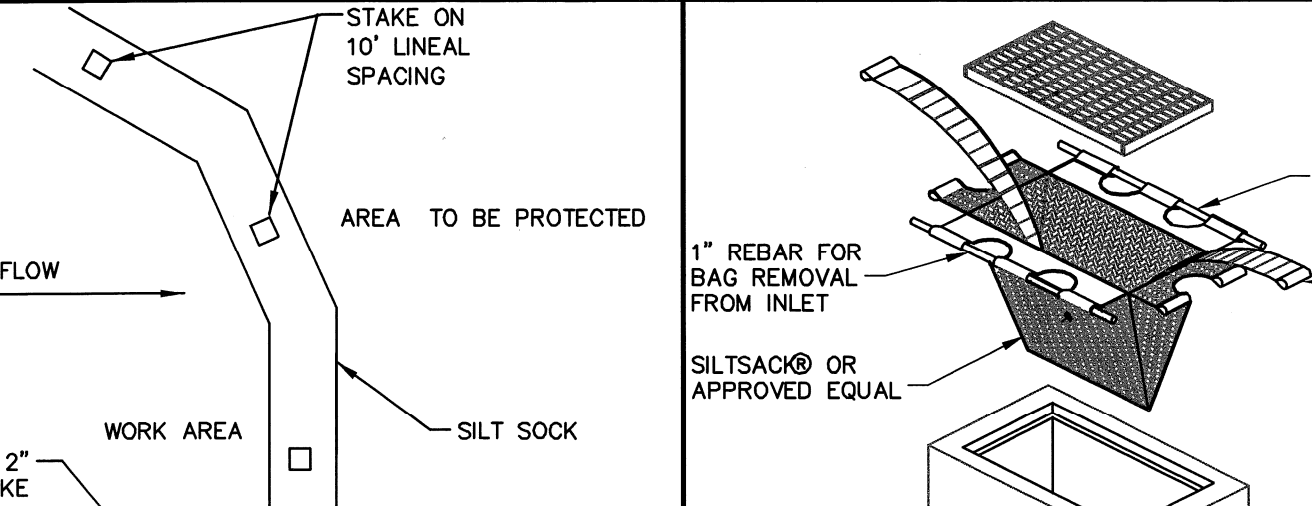
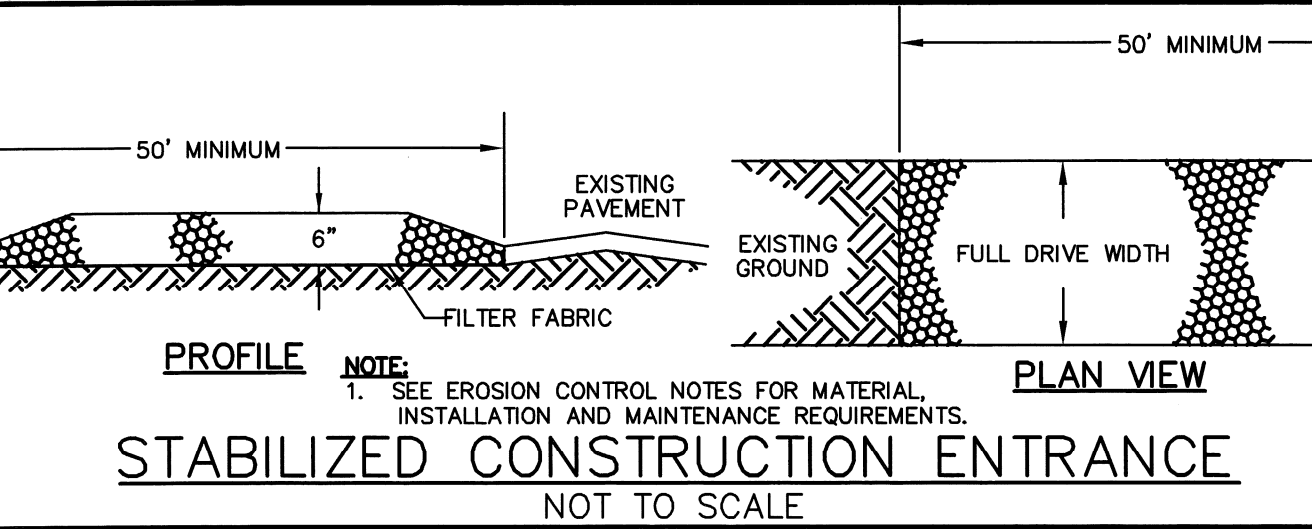
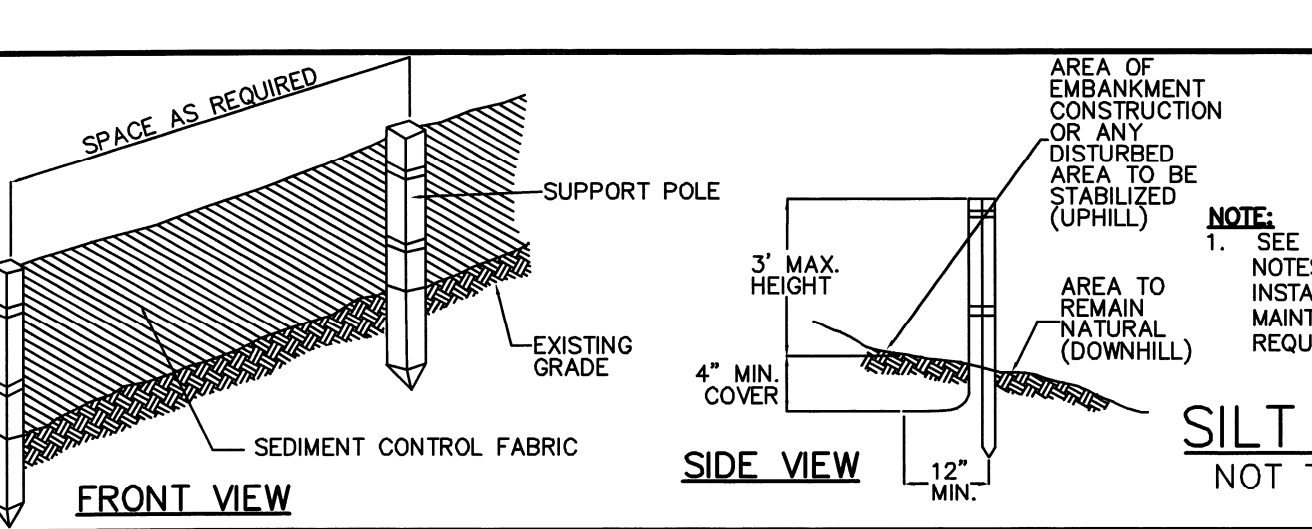
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- 1. PREVENTION OF MISFIRE: APPROPRIATE PRACTICES SHALL BE DEVELOPED AND IMPLEMENTED TO PREVENT MISFIRES... 2. THE FUEL HANDLING REQUIREMENTS SHALL INCLUDE: CONTAINERS CONTAINING REGULATED SUBSTANCES CLOSED AND SEALED...



177 Corporate Drive Portsmouth, NH 03801 www.tighebond.com



Peak Campus Development, LLC The Lodges at West Edge Durham, NH

Table with 2 columns: Date, Description. Rows include 6/11/13 ISSUED FOR BUILDING PERMIT, 1/30/13 REVISED PER AOT COMMENTS, 1/11/12 REVISED FOR PB SUBMISSION, 9/28/12 REVISED FOR PB SUBMISSION, 8/22/12 PB SUBMISSION.

PROJECT NO: P0637 FILE: P0637\_DETAILS.dwg DRAWN BY: KAMISLKC1 CHECKED: JMP2 APPROVED BY: GMM EROSION CONTROL NOTES AND DETAILS SHEET SCALE: AS SHOWN SHEET 15