






University of New Hampshire HOLLOWAY COMMONS RENOVATIONS



V	ABOVE	EQ	EQUAL	LVR	LOUVER	SD	STORM DRAIN
OUST	ACOUSTIC	ETR	EXISTING TO REMAIN	MAS	MASONRY	SF	SQAURE FEET
PS	ALUMINUM COMPOSIT PANEL SYSTEM		EXPOSED TO STRUCTURE	MATL	MATERIAL.	SG	SHEET GOODS
Т	ACOUSTIC CEILING TILE	EWC	ELECTRIC WATER COOLER	MAX	MAXIMUM	SIM	SIMI AR
J	ADJUSTABLE	EXIST	EXISTING	MB	MARKER BOARD	SPEC	SPECIFICATION(S)
	ABOVE FINISHED FLOOR	EXP	EXPANSION	MDO	MEDIUM DENSITY OVERLAY BOARD	SQ	SOUARE
	ALTERNATE	EXT	EXTERIOR	MECH	MECHANICAL	SS	STAINLESS STEEL
JM	ALUMINUM	FACT	FACTORY	MEMB	MEMBRANE	SSF	SOLID SURFACING
	ACCESS PANEL	FC	FIXTURE CONTRACTOR	MIN	MINIMUM	ST	STONE TILE
	BULLETIN BOARD	FCU	FAN COIL UNIT	MISC	MISCELLANEOUS	STC	
OG .	BUILDING	FD	FLOOR DRAIN	MO	MASONRY OPENING		SOUND TRANSMITTION COEFFICIES
G	BLOCKING	FE	FIRE EXTINGUISHER	MR	MOISTURE RESISTANT	STD	STANDARD
	BEAM	FEC	FIRE EXTINGUISHER CABINET	MT	MUISTURE RESISTANT	STL	STEEL
	BOTTOM OF	FF	FINISHED FLOOR	MTD	MARBLE THRESHOLD	STRUC	STRUCTURAL
	BACKER ROD	FHC	FIRE HOSE CABINET		MOUNTED(N)	SUSP	SUSPENDED
VIN	BETWEEN	FIN	FINISH(ED)	MTL	METAL	SV	SHEET VINYL FLOORING
1	CONTRACTOR FURNISHED	FLR		NAT	NATURAL FINISH	TB.	TACKBOARD
45			FLOOR	NF	NATURAL FINISH	TER	TO BE REMOVED
Æ	CONTRACTOR INSTALLED	FND	FOUNDATION	NIC	NOT IN CONTRACT	TD	TRENCH DRAIN
N-	COLD FORMED METAL FRAMING	FO	FACE OF	NO	NUMBER	TEL	TELEPHONE
	CORNER GUARD	FOC	FACE OF CONCRETE	NOM	NOMINAL	TEMP	TEMPERED, TEMPERATURE
	CAST IN PLACE	FOM	FACE OF MASONRY	NTS	NOT TO SCALE	TERR	TARRAZZO
	CONTROL JOINT	FRM	FIRE TREATED	oc	ON CENTER	THERSH	THRESHOLD
	CEILING	FRP	FIBER REINFORCED	OD	OUTSIDE DIAMETER	THK	THICK
	CLEAR		PLASTIC COATED PANELS	OFCI	OWNER FURNISH CONTRACTOR INSTALL	TO	TOP OF
	CERAMIC MOSAIC TILE	FS	FOOD SERVICE	OH	OPPOSITE HAND	TOC	TOP OF CONCRETE
J	CONCRETE MASONRY UNIT	FT	FIRE TREATED	OPNG	OPENING	TOS	TOP OF STEEL
220	COLUMN	FV	FRAME	OPP	OPPOSITE	TV	TELEVISION
AC.	CONCRETE	GA	GAGE GAUGE	PERF	PERFORATED	TYP	TYPICAL
VST:	CONSTRUCTION	GALV	GALVANIZED	PF	PANEL FARRIC	UIS	UNDERSIDE
VT.	CONTINUOUS	GB	GRAB BAR	PLAM	PLASTIC LAMINATE	UC	UNDERCUT
ORD	COORDINATE	GWB	GYPSUM WALLBOARD	PLAS	PLASTER	UNO	
	CARPET	GWT	GLAZED WALL TILE	PLYWD	PLYWOOD	V	UNLESS NOTED OTHERWISE
	CARD READ(ER)	HB	HOSE RIPR	POLYISO	POLYISO CYANURATE		VENT / VENTILATION
	CERAMIC TILE	HC	HOLLOW CORE	PR	PAIR	VB	VAPOR BARRIER, VINYL BASE
	COURSE(S)	HCP	HANDYCAPPED	PT		VCT	VINYL COMPOSITE TILE
	CENTER	HDW	HARDWARE	PTD	PRESSURE TREATED, PAINT	VERT	VERTICAL
3	CURTAIN WALL SYSTEM	HM	HOLLOW METAL		PAINTED	VIF	VERIFY IN FIELD
s	DIRECT APPLIED FINISH SYSTEM	HO		QT	QUARRYTILE	VNL	VINYL
0	DEMOLISH	HORIZ	HOLD OPEN (EG. DOOR)	R	RADIUS	VP	VISION PANEL
	DRINKING FOUNTAIN	HP	HORIZONTAL	RA	RUBBERIZED ASPHALT	WP	VINYL WALL COVERING
	DIAMETER	HT	HIGH POINT	RBR	RUBBER	W/I	WITHIN
			HEIGHT	RD	ROOF DRAIN	W/O	WITHOUT
2	DIMENSION	HWH	HOT WATER HEATER	REC	RECESSED	W/	WITH
*	DISPENSER	ID	INSIDE DIAMETER	REINF	REINFORCED	WC	WATER CLOSET
	DOWN	INSUL	INSULATE(D) (ION)	RELOC	RELOCATE(D)	WD	WOOD
	DOOR	INT	INTERIOR	REQ	REQUIRED	WH	WALL HUNG
3S	DRAWING(S)	JAN	JANITOR'S CLOSET	REV -	REVIS(ED) (ION)	WP	WATER PROOF WORKING POINT
	EXISTING	JT	JOINT	RGWB	RESILIENT GWB CONSTRUCTION	WR	WATER RESISTANT
	EACH	KEC .	KITCHEN EQUIPMENT CONTRACTOR	RH	RIGHT HAND	WSCT	WAINSCOT
		LAM	LAMINATE(D)	RM	ROOM	WT	WEIGHT
		LAV	LAVATORY	RO	ROUGH OPENING	WWF	WELDED WIRE FABRIC
2		LCC	LEAD COATED COPPER	RWI.	RAIN WATER LEADER	XR	X-RAY VIEWER
V	ELEVATION	LOC	LOCATION	S	SEALANT	ALC:	ATOL VIEWER
		LP	LOW POINT	SC	SOLID CORE		

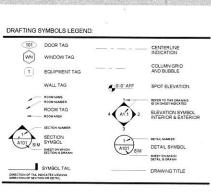

ALTERNATES

A0 32	DEMO EXTERIOR ELEVATIONS
A1.0	GROUND FLOOR PLAN
A1.1	FIRST FLOOR PLAN
A1.2	SECOND FLOOR PLAN
A1.3	UPPER TERRACE PLAN
A1.4	THIRD FLOOR PLAN
A1.5	ATTIC FLOOR PLAN
A1.6	ROOF PLAN
A2 1	GROUND FLOOR AND FIRST FLOOR REFLECTED CEILING PLAN
A2.2	SECOND FLOOR REFLECTED CEILING PLAN
A2.3	UPPER TERRACE REFLECTED CEILING PLAN
A2.4	THIRD FLOOR REFLECTED CEILING PLAN
A3.1	EXTERIOR ELEVATIONS
A3 2	EXTERIOR ELEVATIONS
A3.3	BUILDING SECTIONS
A4.1	WALL SECTIONS
A5.1	EXTERIOR DETAILS
A5.2	EXTERIOR DETAILS
A5 3	EXTERIOR DETAILS
A5.4	EXTERIOR DETAILS
A5 5	EXTERIOR DETAILS
A6.1	CURTAINWALL & STOREFRONT TYPES
A6 2	WINDOW DETAILS
A7.1	STAIR PLANS & SECTIONS
A7.2	STAIRS PLANS, SECTIONS & DETAILS
A7.3	ELEVATOR PLANS & SECTIONS
A8 1	INTÉRIOR ELEVATIONS
A8.2	INTERIOR ELEVATIONS
A8 3	INTERIOR ELEVATIONS
A8.4	INTERIOR ELEVATIONS
A8.5	ENLARGED PLANS AND INTERIOR ELEVATIONS
A9.00	WALL TYPES
A9 01	DOOR SCHEDULE AND DETAILS
A9 02	INTERIOR DETAILS
A9.03	MILLWORK DETAILS
A9.04	CEILING DETAILS
A9.05	SIGNAGE
A9.06	SIGNAGE PLANS
A9 07	NOT USED
A9 08	NOT USED
A9 09	NOT USED


	A9.15	NOT USED
	A9.16	NOTUSED
ABBREVIATIONS	A9.17	NOT USED
DEMOLITION PLAN	A9.18	NOT USED
	A9 19	NOT USED
	A9 20	NOT USED
	A9 21	SECOND FLOOR FURNITURE PLAN
	A9 22	UPPER TERRACE AND THIRD FLOOR FURNITURE
S	100000	PLAN
	-	I Total
	04 STRU	
SPLANS	S0.1	GENERAL NOTES
YY.	50.2	TYPICAL DETAILS
	S0 3	TYPICAL DETAILS
		ITPICAL DETAILS
	50.4	TYPICAL DETAILS AND SCHEDULES
	S1.1	FOUNDATION/GROUND FLOOR PLAN
	S1.2	FOUNDATION/FIRST FLOOR FRAMING PLAN
	513	LOWER TERRACE FRAMING PLAN
		LOWER TERRACE FRAMING PLAN
	S1.4	SECOND FLOOR FRAMING PLAN
	S1.5	UPPER TERRACE FRAMING PLAN
	S1 6	THIRD FLOOR FRAMING PLAN
441	S1.7	NEW ROOF/EXISTING ATTIC FRAMING PLAN
LAN		
	52.1	COLUMN SCHEDULE AND DETAILS
AN	S2 2	BRACED FRAME ELEVATION AND DETAILS
LAN	53.1	SECTIONS
J	S3.2	SECTIONS
4		
	S3.3	SECTIONS
		•
	05 FIRE S	PROTECTION
	FP0	FIRE PROTECTION NOTES, LEGEND AND
	FFU	ABBREVIATIONS
	-	
	FP0.00	GROUND FLOOR FIRE PROTECTION DEMOLITION
ND FIRST FLOOR	0.0000000000000000000000000000000000000	PLAN
ND FIRST FLOOR	FP0.01	FIRST FLOOR FIRE PROTECTION DEMOLITION
	1	PLAN PLAN
FLECTED CEILING PLAN	FP0 02	
ECTED CEILING PLAN	FF0 02	SECOND FLOOR FIRE PROTECTION DEMOLITION
EG. ED GE.E. I.G. E. I.		PLAN
	FP0.03	THIRD FLOOR FIRE PROTECTION DEMOLITION
	0.0000	PLAN
	FP1.0	GROUND FLOOR FIRE PROTECTION PLAN
	FP1.1	FIRST FLOOR FIRE PROTECTION PLAN
	FP1.2	SECOND FLOOR FIRE PROTECTION PLAN
	FP1.3	UPPER TERRACE FIRE PROTECTION PLAN
	FP1.4	
ONS		THIRD FLOOR FIRE PROTECTION PLAN
	FP1.5	ATTIC FIRE PROTECTION PLAN
ONS		
	06 PLUM	RING
	PO	
		PLUMBING NOTES, LEGEND AND ABBREVIATIONS
	P0 00	GROUND FLOOR PLUMBING DEMOLITION PLAN
	P0.01	FIRST FLOOR PLUMBING DEMOLITION PLAN
	P0 02	SECOND FLOOR PLUMBING DEMOLITION PLAN
	P0 03	
		UPPER TERRACE PLUMBING DEMOLITION PLAN
	P0.04	THIRD FLOOR PLUMBING DEMOLITION PLAN
ST FLOOR REFLECTED	P0.05	ATTIC PLUMBING DEMOLITION PLAN
	P1.0	GROUND FLOOR PLUMBING PLAN
ED CEILING PLAN		
TED CEILING PLAN	P1.1	FIRST FLOOR PLUMBING PLAN
	P1.2	SECOND FLOOR PLUMBING PLAN
CEILING PLAN	P1.3	UPPER TERRACE PLUMBING PLAN
	P1.4	TURD EL COD DI LINDING DI ANI
		THIRD FLOOR PLUMBING PLAN
	P1.5	ATTIC PLUMBING PLAN
	P1.6	ROOF PLUMBING PLAN
		ROOF PLUMBING PLAN
	P1.6 P2.0	ROOF PLUMBING PLAN PLUMBING PART PLANS
	P1.6 P2.0 P3.0	ROOF PLUMBING PLAN PLUMBING PART PLANS PLUMBING DETAILS
	P1.6 P2.0	ROOF PLUMBING PLAN PLUMBING PART PLANS
	P1.6 P2.0 P3.0	ROOF PLUMBING PLAN PLUMBING PART PLANS PLUMBING DETAILS
	P1.6 P2.0 P3.0 P4.0	ROOF PLUMBING PLAN PLUMBING PART PLANS PLUMBING DETAILS PLUMBING SCHEDULES
	P1.6 P2.0 P3.0 P4.0 07 MECH	ROOF PLUMBING PLAN PLUMBING PART PLANS PLUMBING DETAILS PLUMBING SCHEDULES MNCAL
OCMI TYPES	P1.6 P2.0 P3.0 P4.0	ROOF PLUMBING PLAN PLUMBING PART PLANS PLUMBING OBTAILS PLUMBING SCHEDULES MICAL WECHANICAL LEGENDS. ABBREVIATIONS AND
RONT TYPES	P1.6 P2.0 P3.0 P4.0 07 MECH M0.01	ROOF PLUMBING PLAN PLUMBING PART PLANS PLUMBING OBTAILS PLUMBING SCHEDULES PLUMBING SCHEDULES NNCAL MECHANICAL LEGENDS, ABBREVIATIONS AND GENERAL, NOTES
RONT TYPES	P1.6 P2.0 P3.0 P4.0 07 MECH	ROOF PLUMBING PLAN PLUMBING PART PLANS PLUMBING OBTAILS PLUMBING SCHEDULES MICAL WECHANICAL LEGENDS. ABBREVIATIONS AND
	P1.6 P2.0 P3.0 P4.0 07 MECH M0.01	ROOF RUMBING FLAN PLUMBING PART FLANS PLUMBING OSTAILS PLUMBING SCHEDULES NICAL WECHANICAL LEGENDS ABBREVIATIONS AND GENERAL NOTES GROUND FLOOR DUCTWORK PLAN
RONT TYPES	P1.6 P2.0 P3.0 P4.0 07 MECH M0.01 M1.00 M1.01	ROOF RUMBING FLAN PLUMBING DATALS PLUMBING DATALS PLUMBING OSCHEDULES NICAL MECHANICAL LEGENIOS, ABBREVIATIONS AND GENERAL NOTES GROUND FLOOR DUCTWORK PLAN FIRST FLOOR DUCTWORK PLAN
& DETAILS	P1.6 P2.0 P3.0 P4.0 07 MECH M0.01 M1.00 M1.01 M1.02	ROOF RUMBING FLAN FLUMBING PART FLANS FLUMBING DETAILS FLUMBING DETAILS FLUMBING SCHEDULES NUCLL WEICHMACAL LEGGING ABBREVIATIONS AND GROUND FLOOR DUCTWORK FLAN FRST FLOOR DUCTWORK FLAN FRST FLOOR DUCTWORK FLAN FRST FLOOR DUCTWORK FLAN
	P1.6 P2.0 P3.0 P4.0 07 MECH M0.01 M1.00 M1.01 M1.02 M1.03	ROOF RUMBING FLAN PLUMBING DATA IS PLUMBING DATA IS PLUMBING OS CHEDULES NICAL MECHANICAL LEGENIOS, ABBREVIATIONS AND GENERAL NOTES GROUND FLOOR DUCTWORK PLAN SECOND FLOOR PLAN SECOND FLOOR DUCTWORK PLAN SECOND FLOOR DUCTWORK PLAN SECON
& DETAILS	P1.6 P2.0 P3.0 P4.0 07 MECH M0.01 M1.00 M1.01 M1.02 M1.03 M1.04	ROOF PLUMBING PLAN FLUMBING PART PLANS FLUMBING DATALS FLUMBING DATALS FLUMBING DATALS FLUMBING SCHEDULES NICAL MICHANICAL LEGIPIOS ABBREVIATIONS AND GROUND FLOOR DUCTWORK PLAN FRST FLOOR DUCTWORK PLAN LUPPER TERRACE DUCTWORK PLAN LUPPER TERRACE DUCTWORK PLAN THIRD FLOOR DUCTWORK PLAN
& DETAILS	P1.6 P2.0 P3.0 P4.0 07 MECH M0.01 M1.00 M1.01 M1.02 M1.03 M1.04	ROOF PLUMBING PLAN FLUMBING PART PLANS FLUMBING DATALS FLUMBING DATALS FLUMBING DATALS FLUMBING SCHEDULES NICAL MICHANICAL LEGIPIOS ABBREVIATIONS AND GROUND FLOOR DUCTWORK PLAN FRST FLOOR DUCTWORK PLAN LUPPER TERRACE DUCTWORK PLAN LUPPER TERRACE DUCTWORK PLAN THIRD FLOOR DUCTWORK PLAN
& DETAILS	P1.6 P2.0 P3.0 P4.0 07 MECH M0.01 M1.00 M1.01 M1.02 M1.03 M1.04 M1.05	ROOF PLUMBING PLAN PLUMBING PART PLANS PLUMBING DETAILS PLUMBING DETAILS PLUMBING DETAILS PLUMBING DETAILS PLUMBING DETAILS ROOF PLOTTING PLAN FIRST ROOF DUCTWORK PLAN FIRST ROOF DUCTWORK PLAN FIRST ROOF DUCTWORK PLAN THERE DETAILS PLANT PLANT THERE DECORD DUCTWORK PLAN THERE DECORD DUCTWORK PLAN THERE DECORD PLANT PLANT THERE DECORD PLANT THERE DECORD PLANT THERE P
& DETAILS	P1.6 P2.0 P3.0 P4.0 07 MECH M0.01 M1.00 M1.01 M1.02 M1.03 M1.04 M1.05 M2.01	ROOF RUMBING FLAN FLUBBING PART FLANS FLUBBING DETAILS FLUBBING DETAILS FLUBBING DETAILS FLUBBING SCHEDULES NNCAL WECHMACA LEGEDIDS ABBREVIATIONS AND GROUND FLOOR DUCTWORK FLAN FRST FLOOR DUCTWORK FLAN LUPBER TERRACE DUCTWORK FLAN LUPBER TERRACE DUCTWORK FLAN ATTIC DUCTWORK FLAN ATTIC DUCTWORK FLAN ATTIC DUCTWORK FLAN FRST FLOOR PIPHOS FLAN
& DETAILS CONS	P1.6 P2.0 P3.0 P4.0 07 MECH M0.01 M1.00 M1.01 M1.02 M1.03 M1.04 M1.05 M2.01 M2.02	ROOF PLUMBING PLAN PLUMBING DATALS PLUMBING DATALS PLUMBING DATALS PLUMBING SCHOOLES NACAL WECHANICAL LEGENDS ABBREVIATIONS AND GENERAL NOTES GENCIAD FLOOR DUCTWORK PLAN FRST FLOOR DUCTWORK PLAN SECOND FLOOR DUCTWORK PLAN LUPPER TERRACE DUCTWORK PLAN FLOOR PLAN FRST FLOOR PLAN FRST FLOOR PLAN FRST FLOOR PLAN FRST FLOOR PLAN SECOND FLOOR PLAN FRST
& DETAILS	P1.6 P2.0 P3.0 P4.0 07 MECH M0.01 M1.00 M1.01 M1.02 M1.03 M1.04 M1.05 M2.01 M2.02	ROOF PLUMBING PLAN PLUMBING DATALS PLUMBING DATALS PLUMBING DATALS PLUMBING SCHOOLES NACAL WECHANICAL LEGENDS ABBREVIATIONS AND GENERAL NOTES GENCIAD FLOOR DUCTWORK PLAN FRST FLOOR DUCTWORK PLAN SECOND FLOOR DUCTWORK PLAN LUPPER TERRACE DUCTWORK PLAN FLOOR PLAN FRST FLOOR PLAN FRST FLOOR PLAN FRST FLOOR PLAN FRST FLOOR PLAN SECOND FLOOR PLAN FRST
& DETAILS CONS	P16 P20 P30 P40 07 MECH M0 01 M1.00 M1.01 M1.02 M1.03 M1.04 M1.05 M2.01 M2.03	ROOF RUMBING FLAN FLUBBING PART FLANS FLUBBING DETAILS FLUBBING DETAILS FLUBBING DETAILS FLUBBING SCHEDULES NNCAL WECHANGAL LEGERIDS ABBREVIATIONS AND GROUND FLOOR DUCTWORK FLAN FRST FLOOR DUCTWORK FLAN SECOND FLOOR DUCTWORK FLAN THIRD FLOOR DUCTWORK FLAN THIRD FLOOR DUCTWORK FLAN ATTIC DUCTWORK FLAN THIRD FLOOR DICTWORK FLAN THIRD FLOOR DICTWORK FLAN THIRD FLOOR DIPHING FLAN SECOND FLOOR PRING FLAN SECOND FLOOR PRING FLAN SECOND FLOOR PRING FLAN UPPER TERRACE PRING FLAN FROM THE TRANSPORT OF THE TRANSPORT O
& DETAILS ONS FERIOR ELEVATIONS	P16 P20 P30 P40 O7 MECH M0 01 M1 00 M1 03 M1 03 M1 03 M1 05 M2 01 M2 02 M2 03 M2 04	ROOF PLUMBING PLAN PLUMBING DATH PLANS PLUMBING DATH B PLUMBING DATH B PLUMBING SCHOOLES NACAL NECHANICAL LEGENDS ABBREVIATIONS AND GENERAL NOTES GENERAL NOTES GENERAL NOTES SECOND FLOOF DUCTWORK PLAN FRST FLOOR DUCTWORK PLAN LIPPER TERRACE DUCTWORK PLAN ATTO DUCTWORK PLAN IN SECOND FLOOR PRING PLAN UPPER TERRACE PPING PLAN UPPER TERRACE PPING PLAN INFIELD PRING PLAN
& DETAILS CONS	P16 P20 P30 P40 O7 MECH ₂ M1 00 M1 01 M1 02 M1 03 M1 04 M1 05 M2 02 M2 03 M2 03 M2 05	ROOF RUMBING FLAN FLUMBING DATA IT PLANS FLUMBING DATA IS FLUMBING DATA IS FLUMBING DATA IS FLUMBING SCHEDULES NNCAL WECHANICAL LEGENDS ABBREVIATIONS AND GENERAL VOTES GENERAL VOTES SECOND FLOOP DICTIVORIS FLAN LIPEST FERRACE DUCTIVORIS FLAN LIPEST FERRACE DUCTIVORIS FLAN HIED FLOOB DUCTIVORIS FLAN ATTIC DUCTIVORIS FLAN SECOND FLOOR PIPING FLAN SECOND FLOOR PIPING FLAN THEOR FLOOD FLOOR FLAN THEORY FLAN THEORY FLOOR FLAN THEORY FLOOR FLAN THEORY FLOOR FLAN THEORY FLAN THEORY FLOOR FLAN THEORY FLOOR FLAN THEORY FLAN THEORY FLOOR FLOOR FLAN THEORY FLOOR FLOOR FLAN THEORY FLOOR
& DETAILS ONS FERIOR ELEVATIONS	P16 P20 P30 P40 O7 MECH M0 01 M1 00 M1 03 M1 03 M1 03 M1 05 M2 01 M2 02 M2 03 M2 04	ROOF RUMBING FLAN FLUMBING PART PLANS FLUMBING DETAILS FLUMBING DETAILS FLUMBING SCHOOLS RECHNICAL LEGENDS ABBREVIATIONS AND GENERAL NOTES GROUDE FLOOR DUCTWORK FLAN FRST FLOOR DUCTWORK FLAN FRST FLOOR DUCTWORK FLAN LOPER TERRACE DUCTWORK FLAN ATTIC DUCTWORK FLAN FRST FLOOR PINHO FLAN ATTIC DUCTWORK FLAN SECOND FLOOR FINHOS FLAN THERE FLENCH FLAN FRST FLOOR PINHOS FLAN SECOND FLOOR FINHOS FLAN LUMBRI TERRACE PINHOS FLAN ATTIC DUCTWORK FLAN FRST FLOOR PINHOS FLAN LUMBRI TERRACE PINHOS FLAN ATTIC DUCTWORK FLAN SECOND FLOOR FINHOS FLAN LUMBRI TERRACE PINHOS FLAN ATTIC LUCKEL PIPHOS FLAN ATTIC LUCKEL PIPHOS FLAN MECHANICAL SECTIONS
& DETAILS ONS FERIOR ELEVATIONS	P16 P20 P30 P40 O7 MECH M0 01 M1 00 M1 01 M1 03 M1 03 M1 04 M2 01 M2 03 M2 04 M2 04 M2 05 M3 01	ROOF RUMBING FLAN FLUMBING PART PLANS FLUMBING DETAILS FLUMBING DETAILS FLUMBING SCHOOLS RECHNICAL LEGENDS ABBREVIATIONS AND GENERAL NOTES GROUDE FLOOR DUCTWORK FLAN FRST FLOOR DUCTWORK FLAN FRST FLOOR DUCTWORK FLAN LOPER TERRACE DUCTWORK FLAN ATTIC DUCTWORK FLAN FRST FLOOR PINHO FLAN ATTIC DUCTWORK FLAN SECOND FLOOR FINHOS FLAN THERE FLENCH FLAN FRST FLOOR PINHOS FLAN SECOND FLOOR FINHOS FLAN LUMBRI TERRACE PINHOS FLAN ATTIC DUCTWORK FLAN FRST FLOOR PINHOS FLAN LUMBRI TERRACE PINHOS FLAN ATTIC DUCTWORK FLAN SECOND FLOOR FINHOS FLAN LUMBRI TERRACE PINHOS FLAN ATTIC LUCKEL PIPHOS FLAN ATTIC LUCKEL PIPHOS FLAN MECHANICAL SECTIONS
& DETAILS ONS FERIOR ELEVATIONS	P16 P20 P30 P40 O7 MECH M0 01 M1 00 M1 01 M1 03 M1 04 M1 03 M2 01 M2 02 M2 03 M2 04 M2 05 M3 02	ROOF PLUMBING PLAN FLUMBING DATALS FLUMBING DATALS FLUMBING DATALS FLUMBING DATALS FLUMBING DATALS FLUMBING DATALS FLUMBING SCHEDULES NNCAL MECHANICAL LEGENDS ABBREVIATIONS AND GENERAL NOTES GENERAL NOTES GENERAL TO ALL MECHANICAL LEGENDS ABBREVIATIONS AND GENERAL TO ALL MECHANICAL LEGENDS ABBREVIATIONS AND LOPES TERRACE DUCTIVORS PLAN THIRD FLOOD DEUTNORS PLAN THIRD FLOOD DEUTNORS PLAN THIRD FLOOD DEUTNORS PLAN THIRD FLOOD DEPING PLAN THIRD FLOOD PIPING PLAN MECHANICAL SECTIONS MECHANICAL SECTIONS MECHANICAL SECTIONS
& DETAILS ONS FERIOR ELEVATIONS	P16 P20 P30 P40 O7 MECH M0 01 M1 00 M1 00 M1 03 M1 04 M1 05 M2 01 M2 03 M2 04 M2 05 M3 01 M3 01 M3 01 M3 01 M3 01 M4 01 M4 01	ROOF RUMBING FLAN FLUBBING DETAILS FLUBBING DETAILS FLUBBING DETAILS FLUBBING DETAILS FLUBBING SCHOOLES NUMBER NOOTH STATE FROM THE STATE OF THE STA
& DETAILS ONS FERIOR ELEVATIONS	P16 P20 P30 P40 O7 MECH M0 01 M1 00 M1 01 M1 03 M1 04 M1 03 M2 01 M2 02 M2 03 M2 04 M2 05 M3 02	ROOF PLUMBING PLAN FLUMBING DATALS FLUMBING DATALS FLUMBING DATALS FLUMBING DATALS FLUMBING DATALS FLUMBING DATALS FLUMBING SCHEDULES NNCAL MECHANICAL LEGENDS ABBREVIATIONS AND GENERAL NOTES GENERAL NOTES GENERAL TO ALL MECHANICAL LEGENDS ABBREVIATIONS AND GENERAL TO ALL MECHANICAL LEGENDS ABBREVIATIONS AND LOPES TERRACE DUCTIVORS PLAN THIRD FLOOD DEUTNORS PLAN THIRD FLOOD DEUTNORS PLAN THIRD FLOOD DEUTNORS PLAN THIRD FLOOD DEPING PLAN THIRD FLOOD PIPING PLAN MECHANICAL SECTIONS MECHANICAL SECTIONS MECHANICAL SECTIONS
& DETAILS ONS FERIOR ELEVATIONS	P16 P20 P30 P40 07 MECH M0 01 M1 02 M1 03 M1 04 M1 05 M2 02 M2 03 M2 04 M2 05 M3 02 M4 01 M3 02 M4 01 M3 02 M4 01 M5 01	ROOF PLUMBING PLAN PLUMBING DATALS PROBLEM DATALS PROBL
& DETAILS ONS FERIOR ELEVATIONS	P16 P20 P40 O7 MECH M0 01 M1 00 M1 03 M1 03 M1 05 M2 01 M2 02 M2 03 M2 05 M3 01 M3 02 M4 01 M5 02 M5 05 M6 01 M6 01 M6 01 M7 05 M7 06 M7 07 M7 07 M8 0	ROOF PLUMBING PLAN FLUMBING PART PLANS FLUMBING DETAILS FLUMBING DETAILS FLUMBING SCHOOLS FLUMBING SCHOOLS FLUMBING SCHOOLS FLOOR DUCTWORK PLAN FRST FLOOR DUCTWORK PLAN FRST FLOOR DUCTWORK PLAN UPPER TERRACE DUCTWORK PLAN THIRD FLOOR PHING PLAN THE DUCTWORK PLAN THIRD FLOOR PHING PLAN THE DUCTWORK PLAN THIRD FLOOR PHING PLAN THE DUCTWORK PLAN THE TRANSPORT PHING PLAN WECHANICAL SECTIONS MECHANICAL DETAILS MECHANICAL DETAILS MECHANICAL DETAILS MECHANICAL DETAILS MECHANICAL DETAILS MECHANICAL DETAILS
& DETAILS ONS FERIOR ELEVATIONS	P16 P20 P30 P40 O7 MECH M0 01 M1 00 M1 01 M1 02 M1 03 M1 04 M1 05 M2 01 M2 02 M2 03 M2 04 M3 01 M3 01 M3 01 M3 01 M5 01 M5 01	ROOF PLUMBING PLAN PLUMBING DATALS PLUMBING DATALS PLUMBING DATALS PLUMBING OSTALS PLUMBING SCHOOLES NACAL NECHANICAL LEGENDS ABBREVIATIONS AND GENERAL NOTES GENCIAPITAL ONCE GENERAL NOTES GENCIAPITAL ONCE GENCIAPITAL ONCE GENCIAPITAL ONCE FRIST FLORI DUCTWORK PLAN FRIST FLORI DUCTWORK PLAN LUPPER TERRACE PRING PLAN FRIST FLOGR PRING PLAN LUPPER TERRACE SECTIONS MICHARICAL DETALS MICHARICAL DETALS MICHARICAL DETALS
& DETAILS ONS FERIOR ELEVATIONS	P16 P20 P30 P40 O7 MECH M001 M100 M101 M103 M103 M104 M103 M201 M203 M204 M203 M301 M301 M301 M301 M301 M301 M301 M3	ROOF PLUMBING PLAN FLUMBING PART PLANS FLUMBING DETAILS FLUMBING DETAILS FLUMBING SCHEDULES NICAL WESHBAL NOTES GROUDD FLOOD DLCTWORK PLAN FRIST FLOOD DLCTWORK PLAN FRIST FLOOD DLCTWORK PLAN FRIST FLOOD DLCTWORK PLAN LUPPER TERRACE DLCTWORK PLAN ATTIC DUCTWORK PLAN FRIST FLOOD PIPING PLAN FRIST FLOOD PIPING PLAN THERD LOOD PIPING PLAN WECHANICAL SCHEMATES MECHANICAL DETAILS
& DETAILS ONS FERIOR ELEVATIONS	P16 P20 P30 P40 O7 MECH M0 01 M1 00 M1 01 M1 02 M1 03 M1 04 M1 05 M2 01 M2 02 M2 03 M2 04 M3 01 M3 01 M3 01 M3 01 M5 01 M5 01	ROOF PLUMBING PLAN PLUMBING DATALS PLUMBING DATALS PLUMBING DATALS PLUMBING OSTALS PLUMBING SCHOOLES NACAL NECHANICAL LEGENDS ABBREVIATIONS AND GENERAL NOTES GENCIAPITAL ONCE GENERAL NOTES GENCIAPITAL ONCE GENCIAPITAL ONCE GENCIAPITAL ONCE FRIST FLORI DUCTWORK PLAN FRIST FLORI DUCTWORK PLAN LUPPER TERRACE PRING PLAN FRIST FLOGR PRING PLAN LUPPER TERRACE SECTIONS MICHARICAL DETALS MICHARICAL DETALS MICHARICAL DETALS

SUCCT	DRAWING LIST SHEET	
NUMBER	DRAWING TITLE	
MD1.01	FIRST FLOOR DUCTWORK DEMO PLAN	
MD1.02	SECOND FLOOR DUCTWORK DEMO PLAN	
MD1.03 MD1.04	THIRD FLOOR DUCTWORK DEMO PLAN	
MD1.04 MD2.01	ATTIC LEVEL DUCTWORK DEMO PLAN FIRST FLOOR PIPING DEMO PLAN	
MD2 02	SECOND FLOOR PIPING DEMO PLAN	
MD2 03	THIRD FLOOR PIPING DEMO PLAN	
MD2 04	ATTIC PIPING DEMO PLAN	
08 ELECT		
E0 01	ELECTRICAL LEGEND. ABBREVIATIONS & NOTE	
E0 03	ELECTRICAL ONE-LINE ELECTRICAL SCHEDULES	
E0.04	PANELBOARD SCHEDULES	
E0 05	PANELBOARD SCHEDULES	
E0 06	LIGHTING FIXTURE SCHEDULE	
E1.0	GROUND FLOOR LIGHTING PLAN	
E1.1	FIRST FLOOR LIGHTING PLAN SECOND FLOOR LIGHTING PLAN	
E1.2	UPPER TERRACE LIGHTING PLAN	
E1.4	THIRD FLOOR LIGHTING PLAN	
E2.0	GROUND FLOOR POWER PLAN	
E2 1	FIRST FLOOR POWER PLAN	
E2 2	SECOND FLOOR POWER PLAN	
E23	UPPER TERRACE POWER PLAN	
E2.4	THIRD FLOOR POWER PLAN	
E2.5	ATTIC POWER PLAN	
	LIGHTNING PROTECTION PLAN	
E2 7 E3 0	GROUND FLOOR SYSTEMS PLAN	
E3 1	FIRST FLOOR SYSTEMS PLAN	
E3 2	UPPER TERRACE SYSTEMS PLAN	
E3.3	SECOND FLOOR SYSTEMS PLAN	
E3.4	THIRD FLOOR SYSTEMS PLAN	
E3 5	ATTIC SYSTEMS PLAN	
E4.0	ELECTRICAL DETAILS	
E4.1	FIRST FLOOR CONFERENCE PREP & SECOND	
E42	FLOOR DISH ROOM ELECTRICAL PART PLANS SECOND FLOOR KITCHEN ELECTRICAL PART	
E43	PLANS	
E5.0	FIRE ALARM RISER & DETAILS	
E5 1	LIGHTING WIRING DIAGRAMS LIGHTING WIRING DIAGRAMS	
E5.2	LIGHTING WIRING DIAGRAMS	
E5 3	LIGHTING WIRING DIAGRAMS	
E5.4	LIGHTING WIRING DIAGRAMS LIGHTING WIRING DIAGRAMS	
E5.5	LIGHTING WIRING DIAGRAMS	
E5 6	LIGHTING WIRING DIAGRAMS	
E5 7	LIGHTING WIRING DIAGRAMS	
E5 8	LIGHTING WIRING DIAGRAMS	
E5 9	LIGHTING WIRING DIAGRAMS	
E5 10	LIGHTING WIRING DIAGRAMS	
E5 11 E5 12	LIGHTING WIRING DIAGRAMS	
E5 12 E5 13	LIGHTING WIRING DIAGRAMS LIGHTING WIRING DIAGRAMS	
E5 14	LIGHTING WIRING DIAGRAMS	
E5 15	LIGHTING WIRING DIAGRAMS	
E5 16	LIGHTING WIRING DIAGRAMS	
ED1 0	GROUND FLOOR ELECTRICAL DEMO PLAN	
ED1.1	FIRST FLOOR ELECTRICAL DEMO PLAN	
ED1.2	SECOND FLOOR ELECTRICAL DEMO PLAN	
ED1.3	UPPER TERRACE ELECTRICAL DEMO PLAN	
ED1.4	THIRD FLOOR ELECTRICAL DEMO PLAN	
ED1.5	ATTIC ELECTRICAL DEMO PLAN	
09 FOOD S	ERVICE	
QF000 QF100	OVERALL ECONSERVICE VEY BLAN LEVEL 2	
QF100 QF101	OVERALL FOODSERVICE KEY PLAN - LEVEL 2 OVERALL FOODSERVICE KEY PLAN	
QF400	FOOD SERVICE EQUIPMENT PLAN	
QF401	FOODSERVICE UTILITY SCHEDULE	
QF402	FOODSERVICE BUILDING CONDITIONS &	
	VENTILATION PLAN	
QF403	FOODSERVICE PLUMBING PLAN	
QF404	FOODSERVICE ELECTRICAL PLAN	
QF405	FOODSERVICE EQUIPMENT PLAN	
QF406	FOODSERVICE UTILITY SCHEDULE	
QF407	FOODSERVICE BUILDING CONDITIONS & VENTILATION PLAN	
QF408	FOODSERVICE PLUMBING PLAN	
QF409	FOODSERVICE ELECTRICAL PLAN	
	COUNTER TYPICAL DETAILS	
QF601	COUNTER ELEVATION DETAILS	
QF602	COUNTER ELEVATION DETAILS	
QF700	FOODSERVICE ACCUMULATOR DETAILS	
QF701	FOODSERVICE ACCUMULATOR DETAILS	
2F702	FOODSERVICE ACCUMULATOR DETAILS	

	DRAWING LIST	OWNER: UNIVERSITY OF NEW HAMPSHIRE 105 Main Street
SHEET	DRAWING TITLE	Durham, NH 03824 (603) 862-1234
MD1.01	FIRST FLOOR DUCTWORK DEMO PLAN	
MD1.02	SECOND FLOOR DUCTWORK DEMO PLAN	
MD1.03	THIRD FLOOR DUCTWORK DEMO PLAN	ARCHITECT: MDS/MILLER DYER SPEARS
MD1.04 MD2.01	ATTIC LEVEL DUCTWORK DEMO PLAN	99 Chauncy Street
MD2.01	FIRST FLOOR PIPING DEMO PLAN SECOND FLOOR PIPING DEMO PLAN	Boston, MA 02111
MD2 03	THIRD FLOOR PIPING DEMO PLAN	(617) 338-5350
MD2 04	ATTIC PIPING DEMO PLAN	
08 ELECTI	DICAL	
E0 01	ELECTRICAL LEGEND. ABBREVIATIONS & NOTES	MEP/CIVIL/LANDSCAPE RIST-FROST-SHUMWAY
E0.02	ELECTRICAL ONE-LINE	ENGINEERING
E0 03	ELECTRICAL SCHEDULES	ENGINEER: 71 Water Street Laconia, NH 03246
E0 04	PANELBOARD SCHEDULES	(603) 524-4647
E0 05 E0 06	PANELBOARD SCHEDULES LIGHTING FIXTURE SCHEDULE	(000) 024 4041
E1.0	GROUND FLOOR LIGHTING PLAN	
E1.1	FIRST FLOOR LIGHTING PLAN	STRUCTURAL SOUZA, TRUE & PARTNERS
E1.2	SECOND FLOOR LIGHTING PLAN	205 Winter Street, Third Floor
E1.3	UPPER TERRACE LIGHTING PLAN	ENGINEER: Waltham, MA 02451 (617) 926-6100
E1.4	THIRD FLOOR LIGHTING PLAN	(017) 920-0100
E2 0 E2 1	GROUND FLOOR POWER PLAN FIRST FLOOR POWER PLAN	
E2 2	SECOND FLOOR POWER PLAN	
E2 3	UPPER TERRACE POWER PLAN	FOODSERVICE RICCA DESIGN STUDIOS
E2.4	THIRD FLOOR POWER PLAN	5325 South Valentia VVay
E2.5	ATTIC POWER PLAN	DESIGN: Greenwood Village, CO 80111 (781) 659-7377
E2.6	LIGHTNING PROTECTION PLAN	(761) 659-7377
E2 7	GROUND FLOOR SYSTEMS PLAN	
E3 1	FIRST FLOOR SYSTEMS PLAN	
E3 2	UPPER TERRACE SYSTEMS PLAN	GEOTECHNICAL: GSI - GEOTECHNICAL SERVICES INC.
E3.3	SECOND FLOOR SYSTEMS PLAN	55 Notifi Stark Highway
E3.4	THIRD FLOOR SYSTEMS PLAN	Weare, NH 03281
E3.5 E4.0	ATTIC SYSTEMS PLAN	(603) 529-7766
E4.1	ELECTRICAL DETAILS FIRST FLOOR CONFERENCE PREP & SECOND FLOOR DISH ROOM ELECTRICAL PART PLANS	
E4 2	SECOND FLOOR KITCHEN ELECTRICAL PART PLANS	CONSTRUCTION NORTH BRANCH CONSTRUCTION, INC 76 Old Turnpike Road
4.3	FIRE ALARM RISER & DETAILS	MANAGER: Concord, NH 03301
5 0 5 1	LIGHTING WIRING DIAGRAMS	IVIANAGER: (603) 224-3233
5.1	LIGHTING WIRING DIAGRAMS	
5.2	LIGHTING WIRING DIAGRAMS LIGHTING WIRING DIAGRAMS	
5.4	LIGHTING WIRING DIAGRAMS	-
5.5	LIGHTING WIRING DIAGRAMS	
5 6	LIGHTING WIRING DIAGRAMS	
5.7	LIGHTING WIRING DIAGRAMS	
5.8	LIGHTING WIRING DIAGRAMS	
5 9	LIGHTING WIRING DIAGRAMS LIGHTING WIRING DIAGRAMS	
5 11	LIGHTING WIRING DIAGRAMS	-
5.12	LIGHTING WIRING DIAGRAMS	
5 13	LIGHTING WIRING DIAGRAMS	
5.14	LIGHTING WIRING DIAGRAMS	
5 15	LIGHTING WIRING DIAGRAMS	
D10	LIGHTING WIRING DIAGRAMS GROUND FLOOR ELECTRICAL DEMO PLAN	
D1.1	FIRST FLOOR ELECTRICAL DEMO PLAN	
D1 2	SECOND FLOOR ELECTRICAL DEMO PLAN	
D1.3	UPPER TERRACE ELECTRICAL DEMO PLAN	
D1.4	THIRD FLOOR ELECTRICAL DEMO PLAN	
D1.5	ATTIC ELECTRICAL DEMO PLAN	
9 FOOD S	ERVICE FOODSERVICE INDEX	7
F100	OVERALL FOODSERVICE KEY PLAN - LEVEL 2	1
	OVERALL FOODSERVICE KEY PLAN - LEVEL 2	1
F400	FOOD SERVICE EQUIPMENT PLAN	
F401	FOODSERVICE UTILITY SCHEDULE	
F402	FOODSERVICE BUILDING CONDITIONS & VENTILATION PLAN	
F403	FOODSERVICE PLUMBING PLAN	6
	FOODSERVICE PLOMBING PLAN	
F405	FOODSERVICE EQUIPMENT PLAN	
F406	FOODSERVICE UTILITY SCHEDULE	

HOLLOWAY COMMONS RENOVATIONS 75 Main St Durham, NH 03824

CONSTRUCTION DOCUMENTS DATE ISSUED: November 25, 2014 MDS JOB NUMBER:

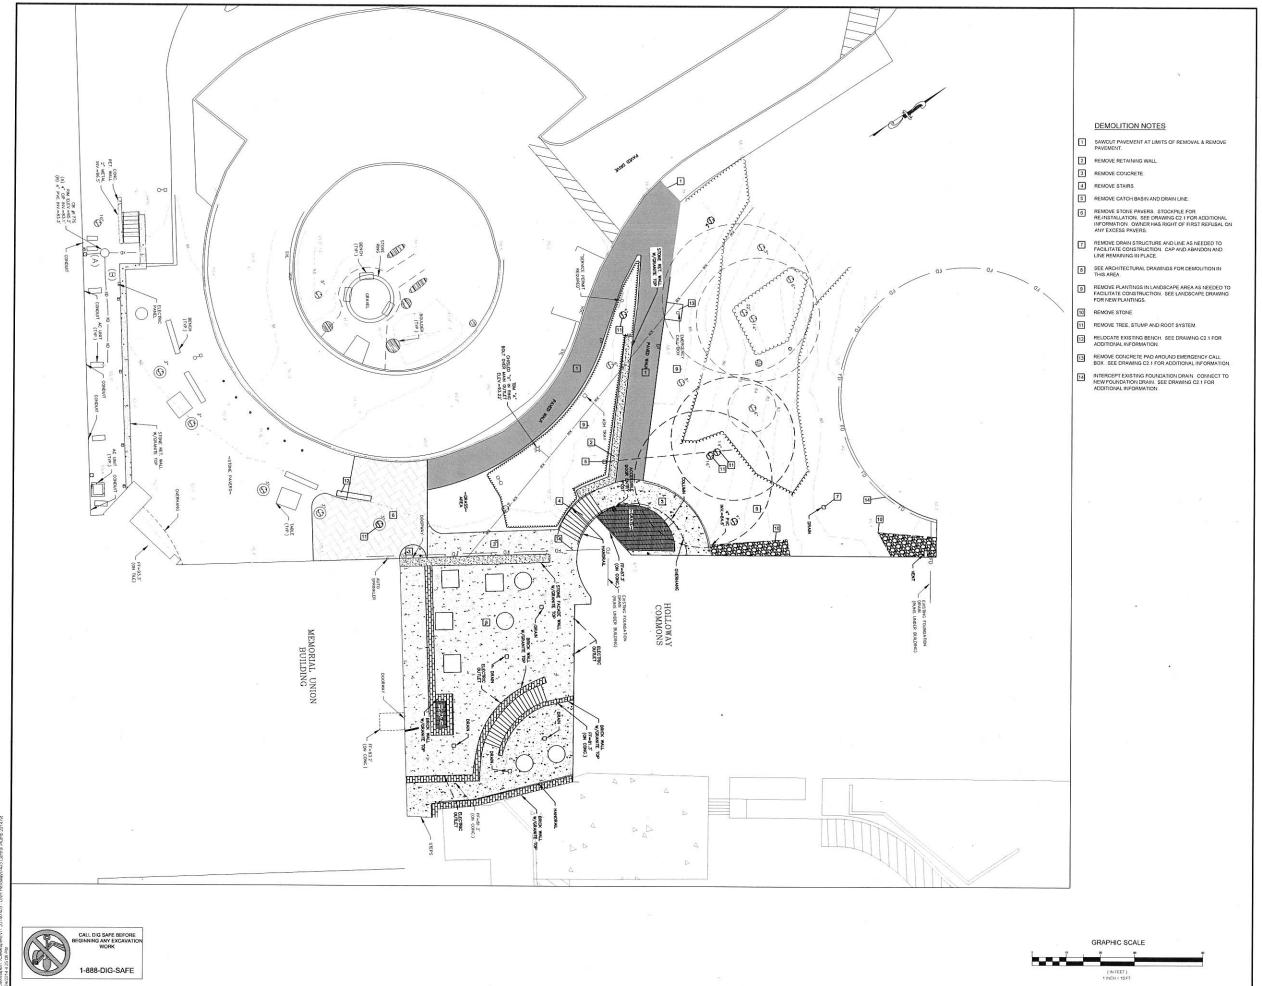






P. 603 524 4647
F: 603 524 7653
www.rfsengineering.com
RF

3.524.7653
rifsengineering.com RFS Project No. 744

and the results of the result

Key Plan

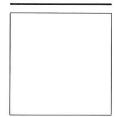

MDS architecture planning interiors

MILLER DYER SPEARS INC. 90 CHAINCY STREET BOSTON, MA 02511 617-338-033 fax WWW MD3-BOS COM

 Project Status.
 CONSTRUCTION DOCUMENTS

 Project No.
 1329

 Drawn By:
 JRI

 Checked By:
 EJJ

 Issue Date:
 NOVEMBER 25, 2014

No. Dete Description

Revision

No	Date	Description	
			_
	-		_
			-
	4		


Drawing Title

EXISTING CONDITIONS & DEMOLITION PLAN

1" = 10'

Drawing Number

C1.1

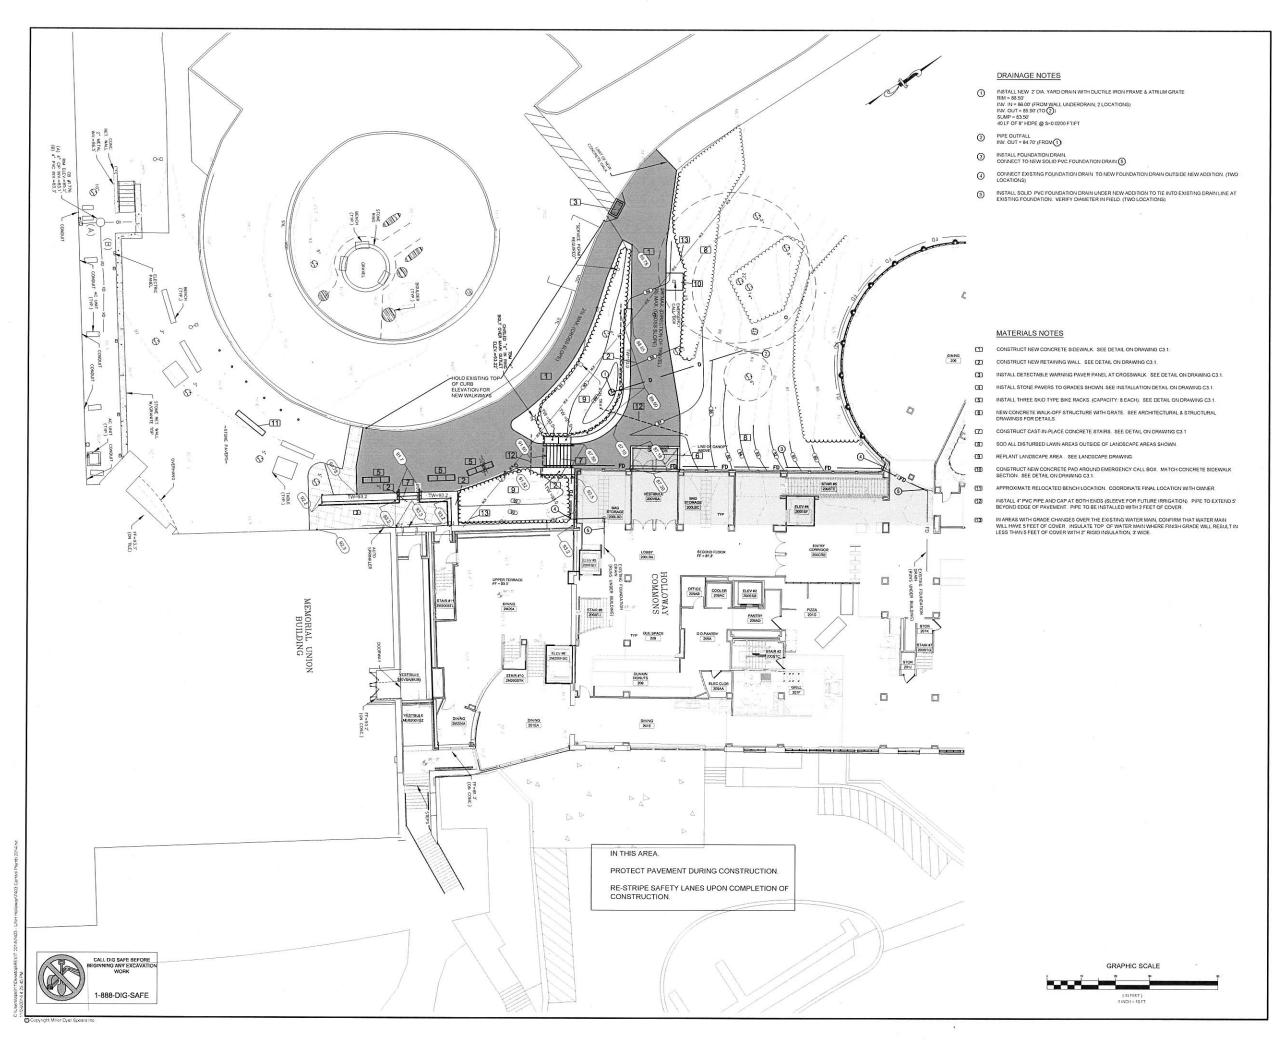





524,7653
feorgineering.com RFS Project No. 740

Walter State Company of the Compa

Key Plan

MILLER DYER SPEARS INC.

BOTOM, MA COTT

WWW.MASAGS.COM

Project Status: CONSTRUCTION DOCUMENTS
Project No: 1329
Drawn By: JRI
Checked By: EJJ
Issue Date: NOVEMBER 25, 2014
Issues
No Date: Clearghon
Revisions
No Date: Cessignon


Drawing Title


SITE PLAN


1" = 10'

Drawing Number


C2.1

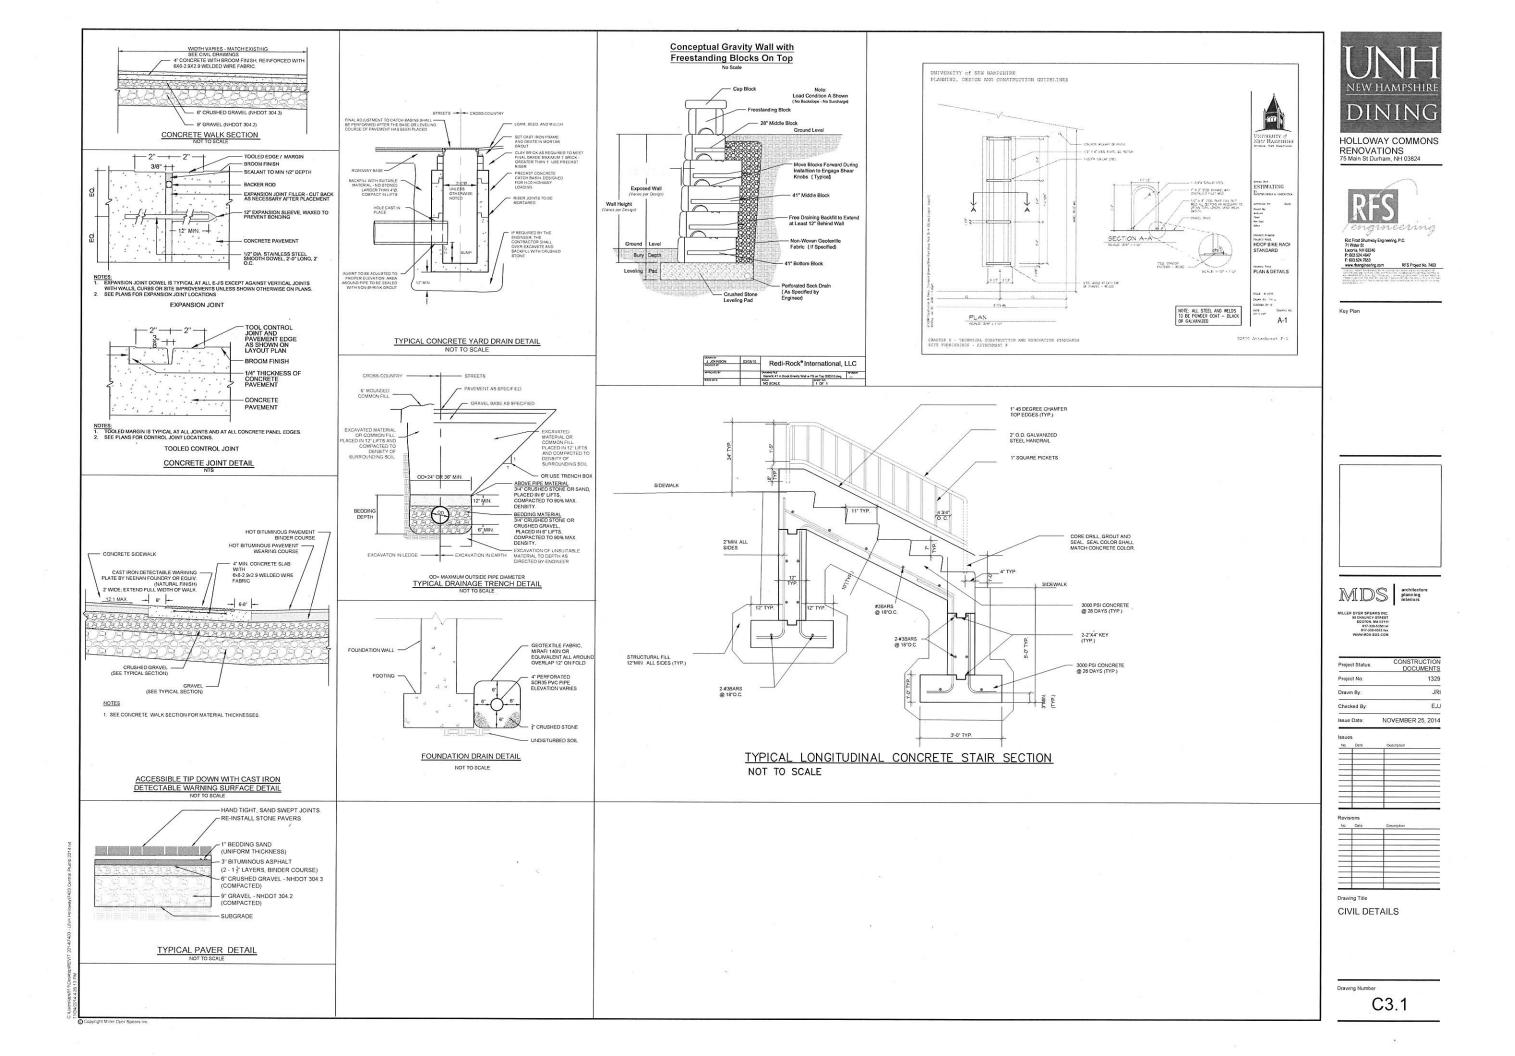


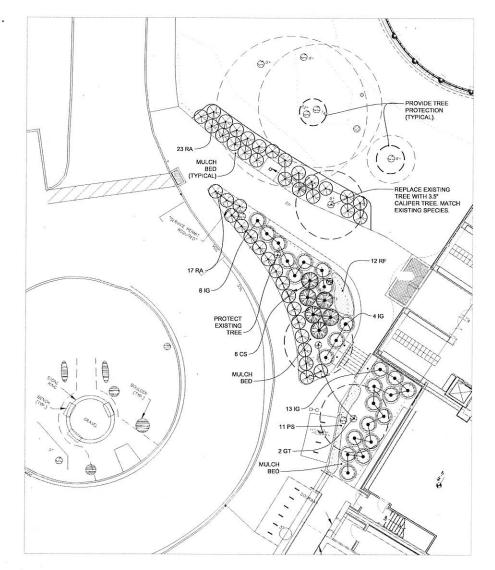


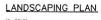


		PLANT LIST		
Symbol	Latin Name	Common Name	Size	Notes
GT	Gledistsia triacanthos inermis 'skyline'	Skyline Honeylocust	3-3.5" cal.	B&B
IG	llex glabra 'Shamrock'	Inkberry	30-36" ht.	5' o.c.
CS	Cornus sericea 'Arctic Fire'	Arctic Fire Dogwood	30-36" ht.	5' o.c.
RA	Rhus aromatica 'Gro-Low'	Grow Low Sumac	#3 pot	4' o.c.
PA	Pennisetum alopecuroides 'Hameln'	Hamlen Fountain Grass	#2 pot	18" o.c.
RF	Rudbeckia fulgida var. fulgida	Black-eyed Susan	#2 pot	18" o.c.

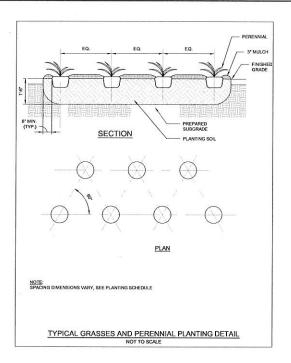

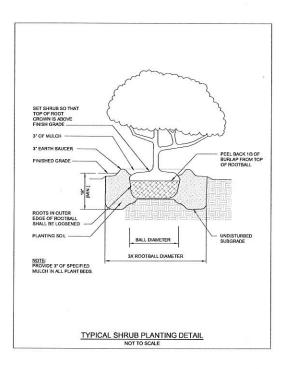

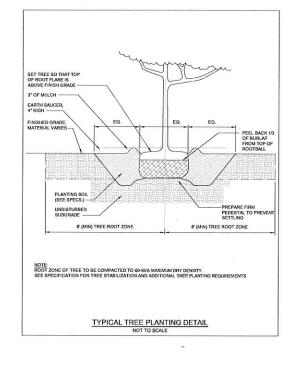

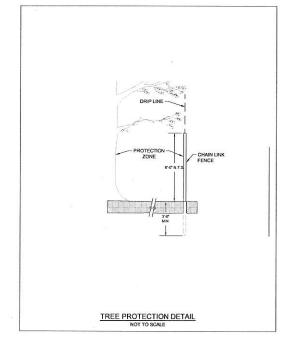





Key Plan



Project Status:	CONSTRUCTIO DOCUMENT
Project No:	132
Drawn By:	F
Checked By:	JT
Issue Date:	NOVEMBER 25, 201

Issues
No Data Descriptor

svisions
to Data Description

Description

Drawing Title

PLANTING PLAN & DETAILS


AS NOTED

Drawing Number

L1.0

SST NDERKIODINEVIT 2014/7403 - UNH Hollowsy/7403 Central Plumb 2014 4:03:38 PM

Convinent Willow Duran Second

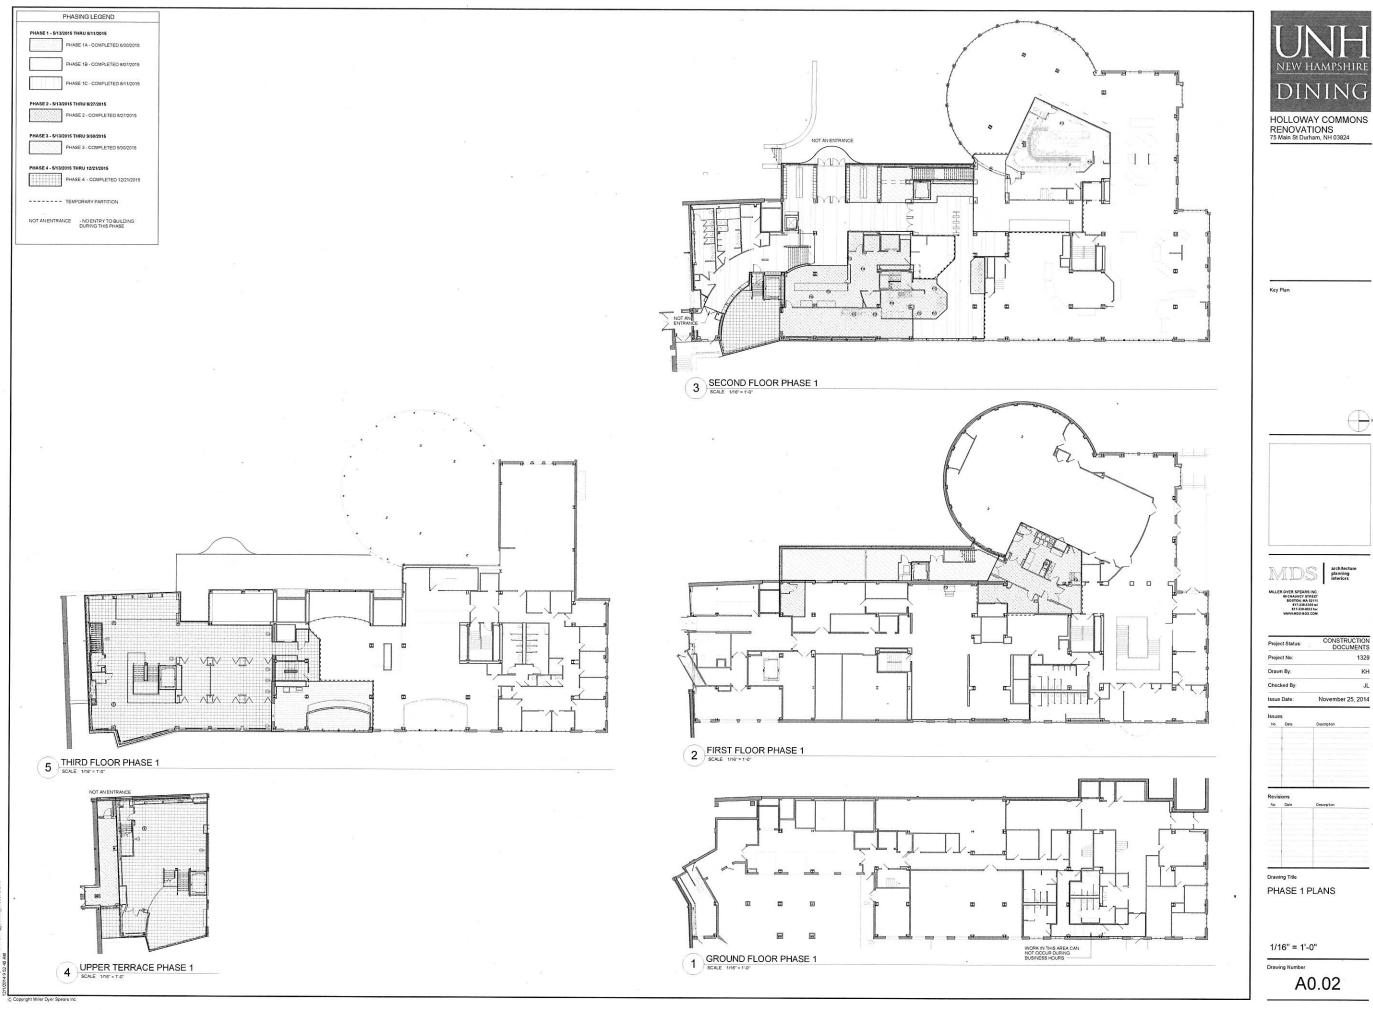





Checked By: Issue Date: November 25, 2014

PHASE 1 PLANS


1/16" = 1'-0"


Drawing Number

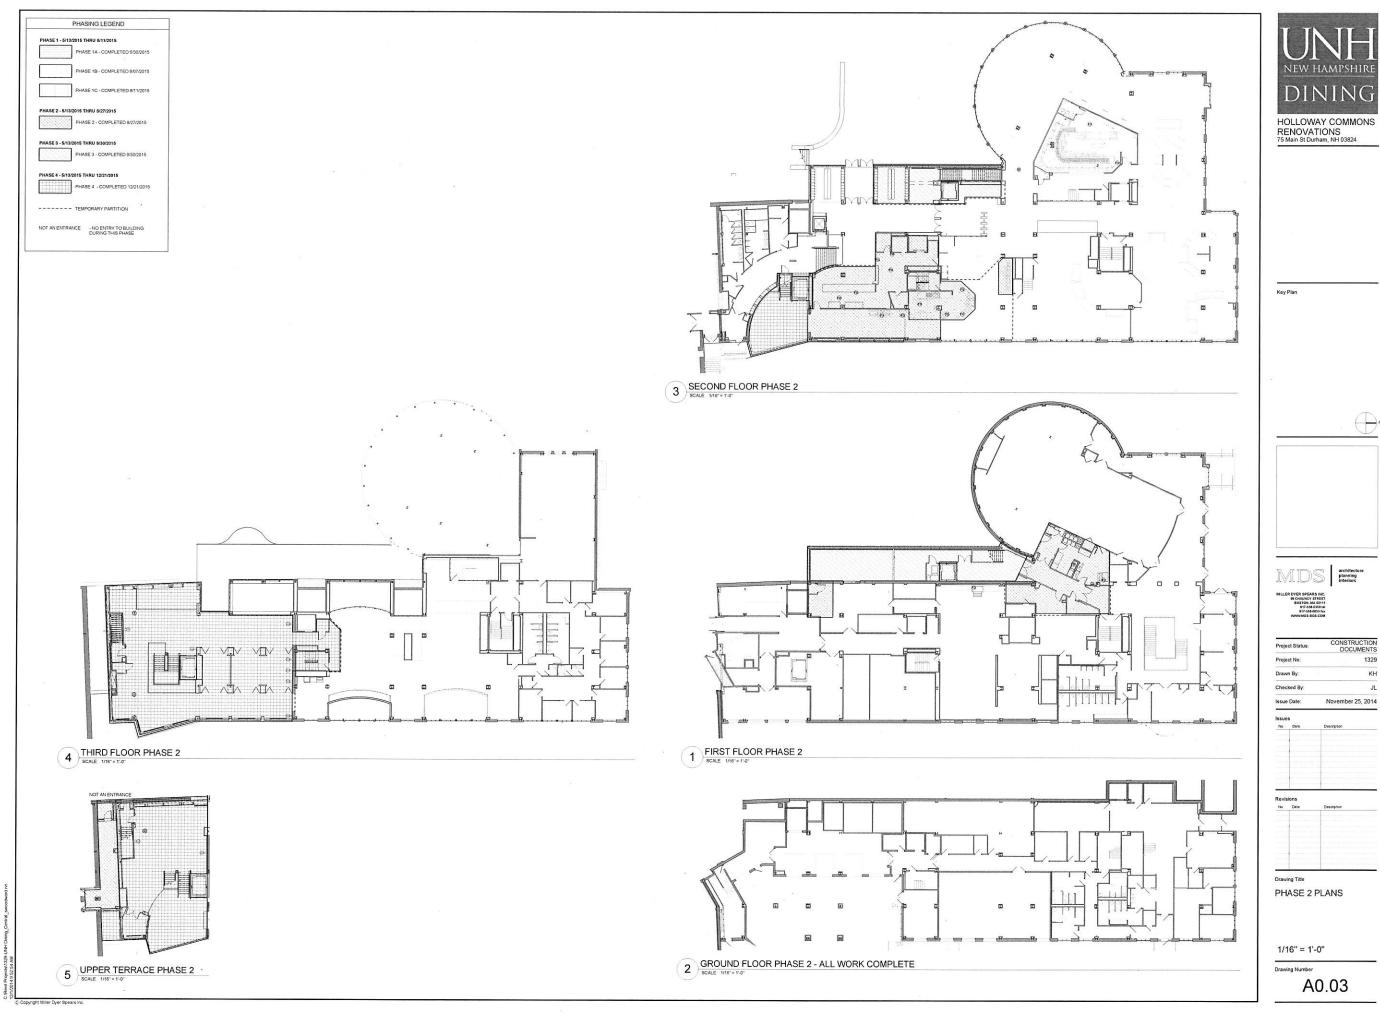

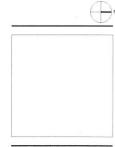

1329 KH November 25, 2014

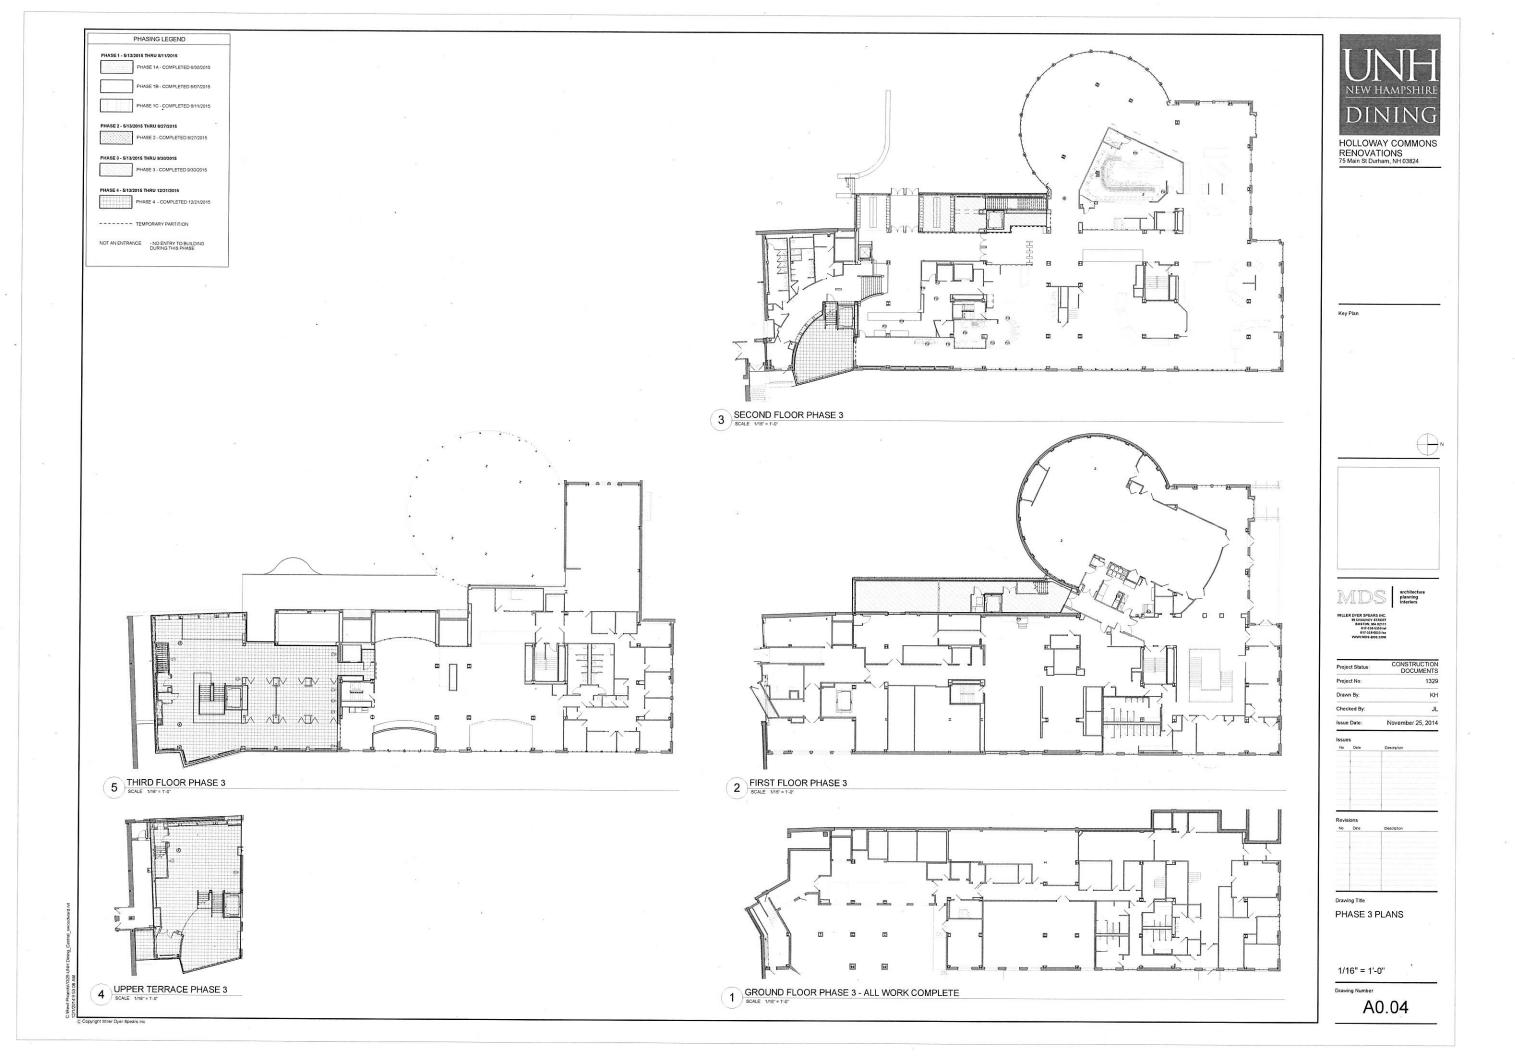

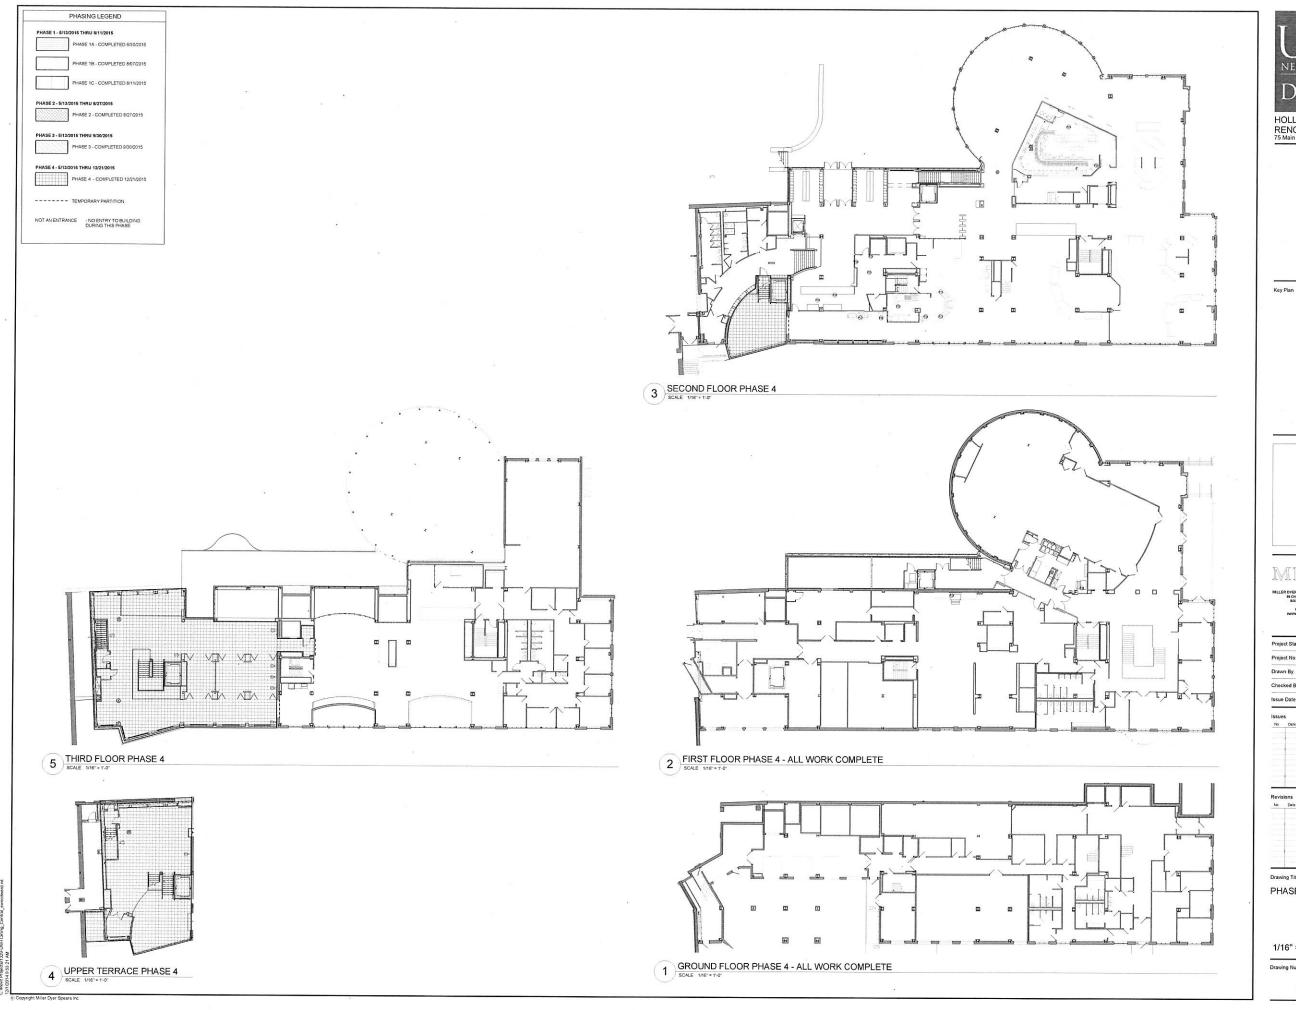





MDS architecture planning interiors


Drawn By: Checked By: Issue Date: November 25, 2014


Drawing Title


PHASE 4 PLANS


1/16" = 1'-0"


Drawing Number

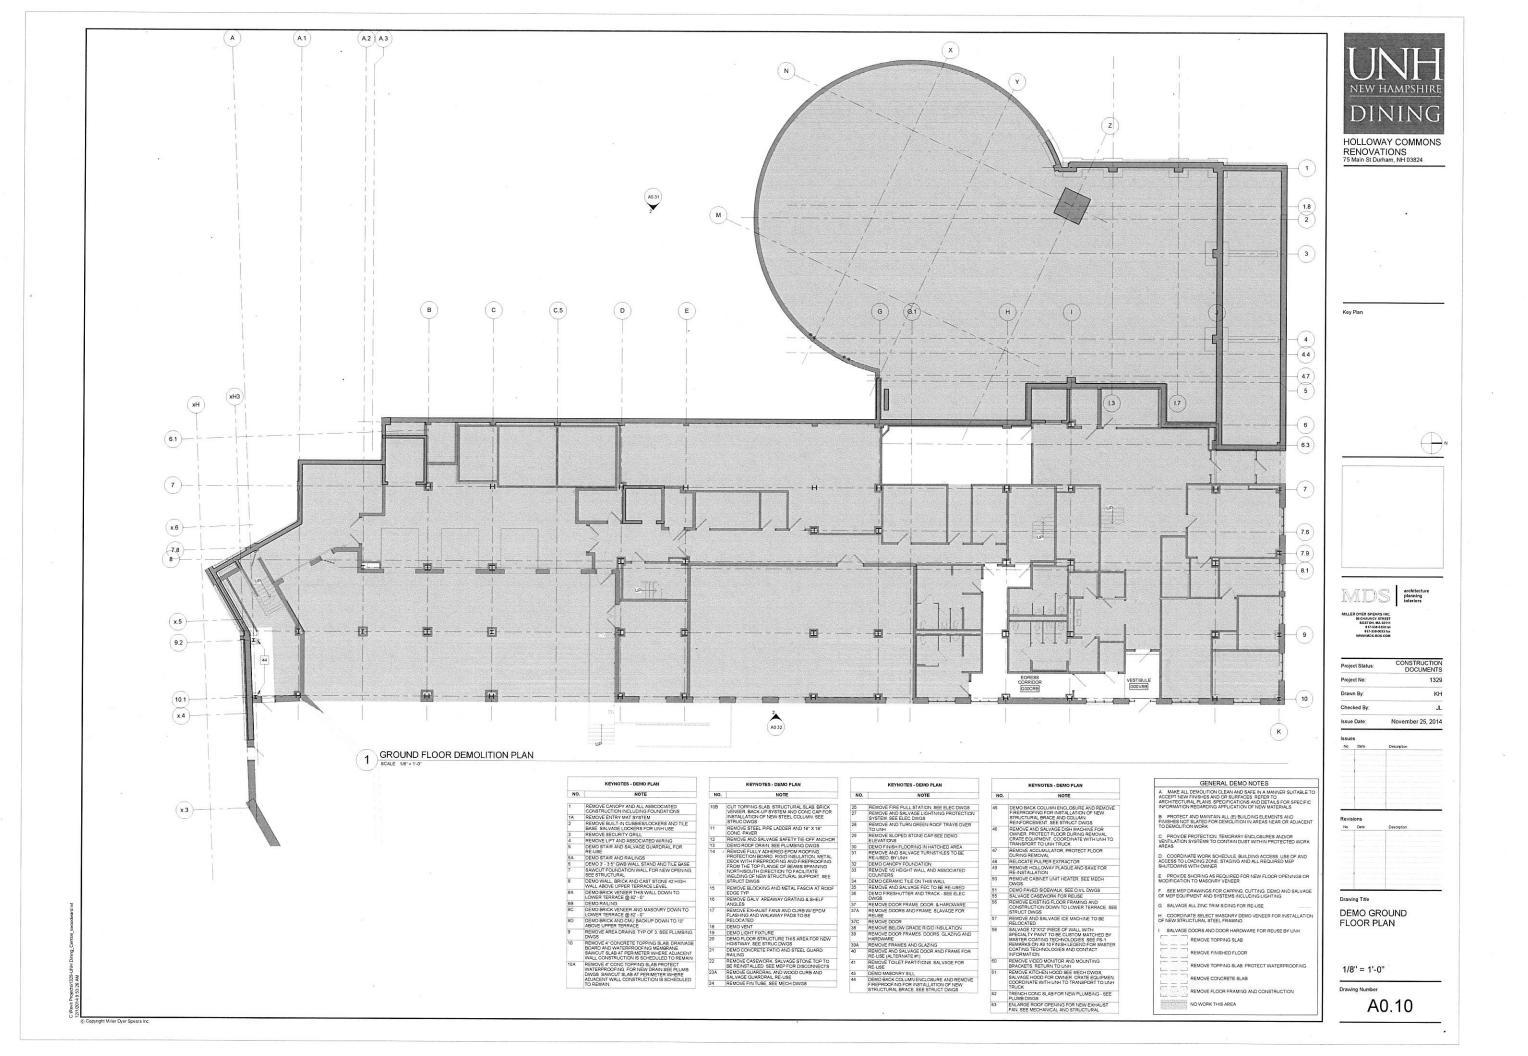

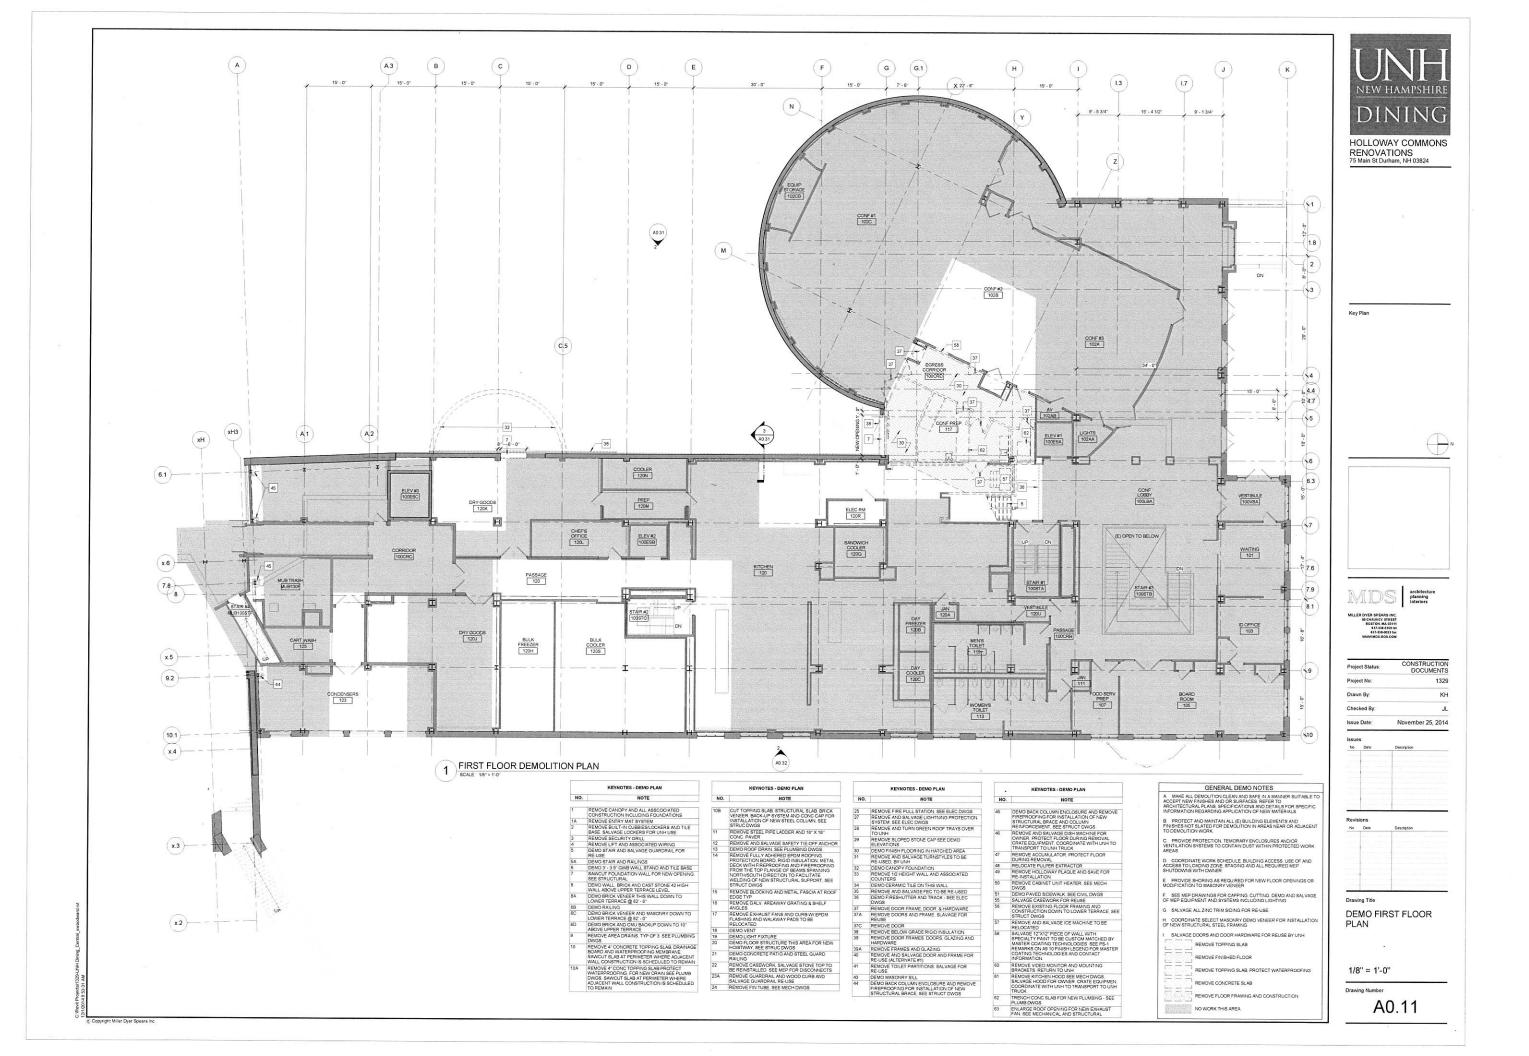

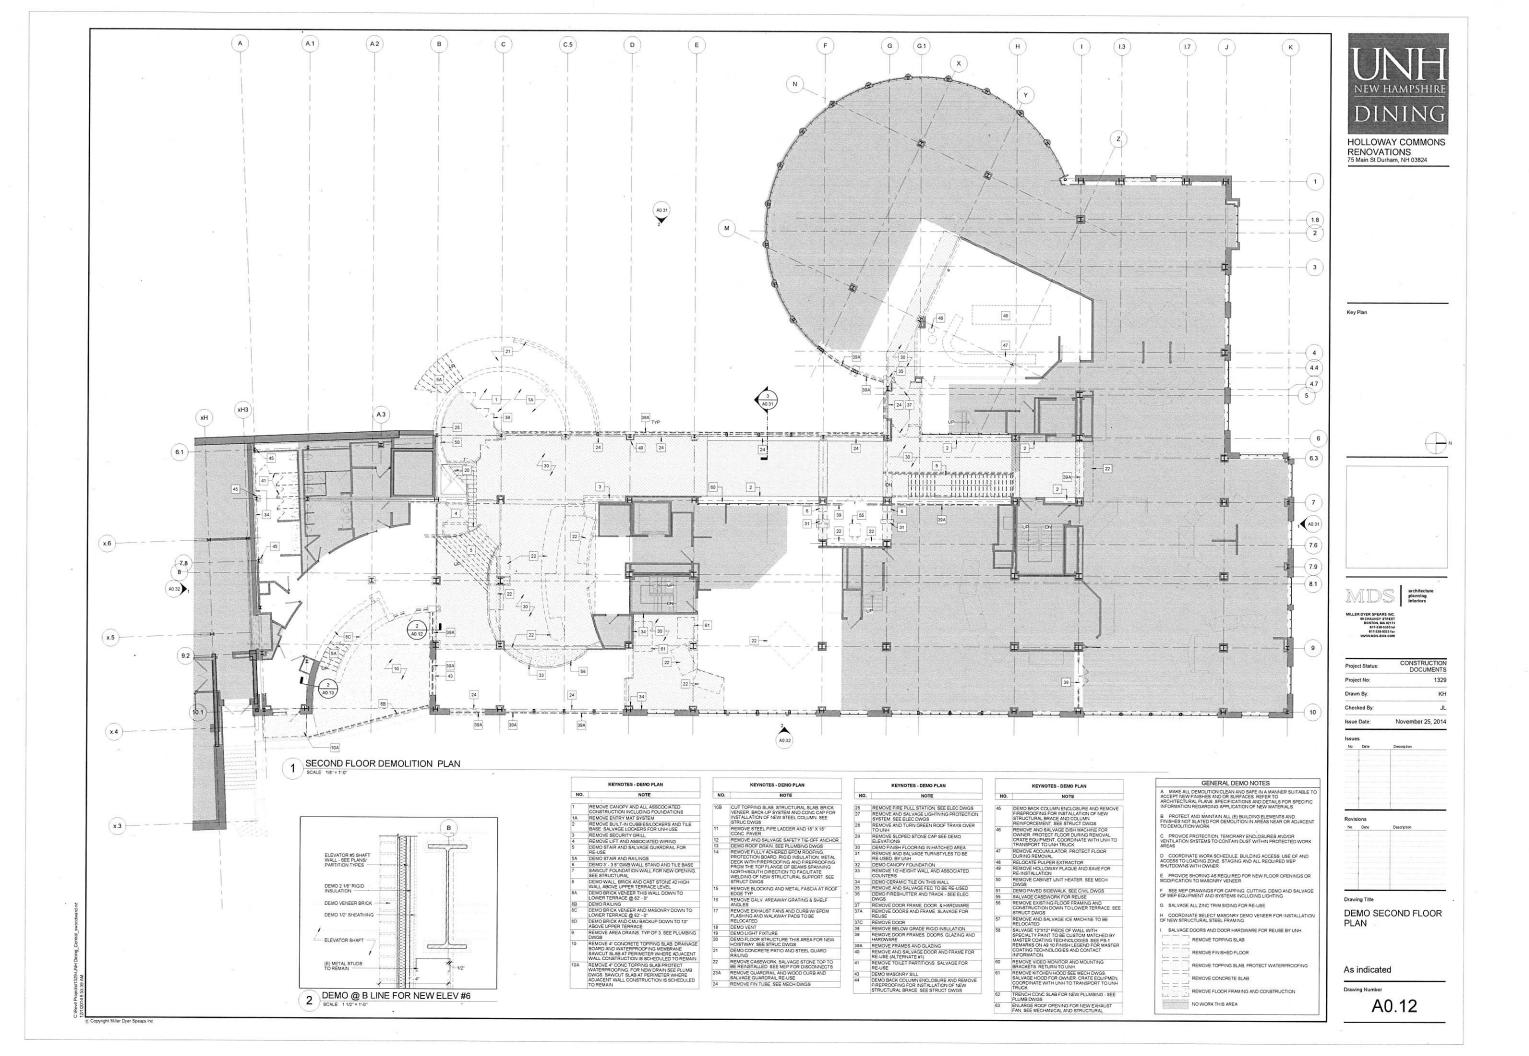

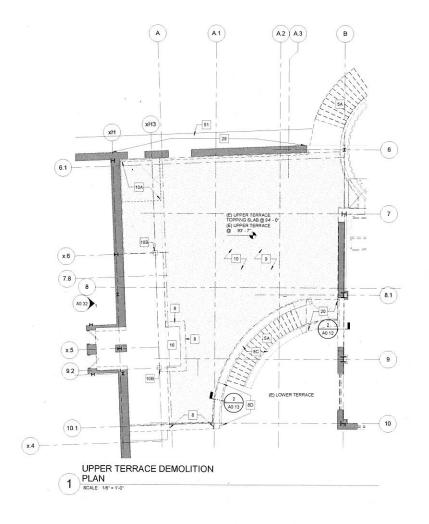

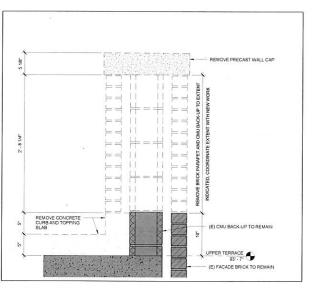

PARAPET DEMO DETAIL @ UPPER TERRACE

KEYNOTES - DEMO PLAN					
NO.	NOTE				
1	REMOVE CANOPY AND ALL ASSCOCIATED CONSTRUCTION INCLUDING FOUNDATIONS				
1A	REMOVE ENTRY MAT SYSTEM				
2	REMOVE BUILT-IN CUBBIES/LOCKERS AND TILE BASE. SALVAGE LOCKERS FOR UNH USE				
3	REMOVE SECURITY GRILL				
4	REMOVE LIFT AND ASSOCIATED WIRING				
5	DEMO STAIR AND SALVAGE GUARDRAIL FOR RE-USE				
5A	DEMO STAIR AND RAILINGS				
6	DEMO 3' - 3.5" GWB WALL STAND AND TILE BASE				
7	SAWCUT FOUNDATION WALL FOR NEW OPENING. SEE STRUCTURAL				
8	DEMOWALL BRICK AND CAST STONE 42 HIGH WALL ABOVE UPPER TERRACE LEVEL				
8A	DEMO BRICK VENEER THIS WALL DOWN TO LOWER TERRACE @ 82' - 0"				
8B	DEMO RAILING				
8C	DEMO BRICK VENEER AND MASONRY DOWN TO LOWER TERRACE @ 82' - 0"				
8D	DEMO BRICK AND CMU BACKUP DOWN TO 10" ABOVE UPPER TERRACE				
9	REMOVE AREA DRAINS, TYP OF 3, SEE PLUMBING DWGS				
10	REMOVE 4" CONCRETE TOPPING SLAB, DRAINAGE BOARD AND WATERFROOFING MEMBRANE SAWCUT SLAB AT PERIMETER WHERE ADJACENT WALL CONSTRUCTION IS SCHEDULED TO REMAIN				
10A	REMOVE 4" CONC TOPPING SLAB PROTECT WATERPROOFING, FOR NEW DRAIN SEE PLUMB DWGS. SAWCUT SLAB AT PERIMETER WHERE ADJACENT WALL CONSTRUCTION IS SCHEDULED TO REMAIN.				

NO.	NOTE
108	CUT TOPPING SLAB, STRUCTURAL SLAB, BRICK VENEER, BACK-UP SYSTEM AND CONG CAP FOR INSTALLATION OF NEW STEEL COLUMN, SEE STRUC DWGS
11	REMOVE STEEL PIPE LADDER AND 18" X 18" CONC. PAVER
12	REMOVE AND SALVAGE SAFETY TIE-OFF ANCHOR
13	DEMO ROOF DRAIN, SEE PLUMBING DWGS
14	REMOVE FULLY ADJERED EPOM ROOFING. PROTECTION BOADD. RIGID INSULATION, METAL DECK WITH FIREPROOFING AND FIREPROOFING FROM THE TOP FLANGE OF BEAMS SPANNING NORTH/SOUTH DIRECTION TO PACILITATE WELDING OF NEW STRUCTURAL SUPPORT, SEE STRUCT DWGS
15	REMOVE BLOCKING AND METAL FASCIA AT ROOF EDGE TYP
16	REMOVE GALV AREAWAY GRATING & SHELF ANGLES
17	REMOVE EXHAUST FANS AND CURB W/ EPDM FLASHING AND WALKWAY PADS TO BE RELOCATED
18	DEMO VENT
19	DEMO LIGHT FIXTURE
20	DEMO FLOOR STRUCTURE THIS AREA FOR NEW HOISTWAY, SEE STRUC DWGS
21	DEMO CONCRETE PATIO AND STEEL GUARD RAILING
22	REMOVE CASEWORK, SALVAGE STONE TOP TO BE REINSTALLED. SEE MEP FOR DISCONNECTS
23A	REMOVE GUARDRAIL AND WOOD CURB AND SALVAGE GUARDRAIL RE-USE
24	REMOVE FIN TUBE, SEE MECH DWGS

NO.	NOTE
25	REMOVE FIRE PULL STATION, SEE ELEC DWGS
27	REMOVE AND SALVAGE LIGHTNING PROTECTION SYSTEM, SEE ELEC DWGS
28	REMOVE AND TURN GREEN ROOF TRAYS OVER TO UNH
29	REMOVE SLOPED STONE CAP SEE DEMO ELEVATIONS
30	DEMO FINISH FLOORING IN HATCHED AREA
31	REMOVE AND SALVAGE TURNSTYLES TO BE RE-USED, BY UNH
32	DEMO CANOPY FOUNDATION
33	REMOVE 1/2 HEIGHT WALL AND ASSOCIATED COUNTERS
34	DEMO CERAMIC TILE ON THIS WALL
35	REMOVE AND SALVAGE FEC TO BE RE-USED
36	DEMO FIRESHUTTER AND TRACK - SEE ELEC DWGS
37	REMOVE DOOR FRAME, DOOR, & HARDWARE
37A	REMOVE DOORS AND FRAME, SLAVAGE FOR REUSE
37C	REMOVE DOOR
38	REMOVE BELOW GRADE RIGID INSULATION
39	REMOVE DOOR FRAMES, DOORS, GLAZING AND HARDWARE
39A	REMOVE FRAMES AND GLAZING
40	REMOVE AND SALVAGE DOOR AND FRAME FOR RE-USE (ALTERNATE #1)
41	REMOVE TOILET PARTITIONS SALVAGE FOR RE-USE
43	DEMO MASONRY SILL
44	DEMO BACK COLUMN ENCLOSURE AND REMOVE FIREPROOFING FOR INSTALLATION OF NEW STRUCTURAL BRACE SEE STRUCT DWGS

NO.	NOTE
45	DEMO BACK COLUMN ENCLOSURE AND REMOVE FIREPROOFING FOR INSTALLATION OF NEW STRUCTURAL BRACE AND COLUMN REINFORCEMENT, SEE STRUCT DWGS
46	REMOVE AND SALVAGE DISH MACHINE FOR OWNER, PROTECT FLOOR DURING REMOVAL CRATE EQUIPMENT, COORDINATE WITH UNH TO TRANSPORT TO UNH TRUCK
47	REMOVE ACCUMULATOR, PROTECT FLOOR DURING REMOVAL
48	RELOCATE PULPER EXTRACTOR
49	REMOVE HOLLOWAY PLAQUE AND SAVE FOR RE-INSTALLATION
50	REMOVE CABINET UNIT HEATER, SEE MECH DWGS
51	DEMO PAVED SIDEWALK, SEE CIVIL DWGS
55	SALVAGE CASEWORK FOR REUSE
56	REMOVE EXISTING FLOOR FRAMING AND CONSTRUCTION DOWN TO LOWER TERRACE, SEE STRUCT DWGS
57	REMOVE AND SALVAGE ICE MACHINE TO BE RELOCATED
58	SALVAGE 12'X12" PIECE OF WALL WITH SPECIALTY PAINT TO BE CUSTOM MATCHED BY MASTER COATING TECHNOLOGIES SEE PS-1 REMARKS ON 49 10 FINISH LEGEND FOR MASTER COATING TECHNOLOGIES AND CONTACT INFORMATION
60	REMOVE VIDEO MONITOR AND MOUNTING BRACKETS RETURN TO UNH
61	REMOVE KITCHEN HOOD SEE MECH DWGS. SALVAGE HOOD FOR OWNER CRATE EQUIPMEN, COORDINATE WITH UNH TO TRANSPORT TO UNH TRUCK
62	TRENCH CONC SLAB FOR NEW PLUMBING - SEE PLUMB DWGS
63	ENLARGE ROOF OPENING FOR NEW EXHAUST FAN. SEE MECHANICAL AND STRUCTURAL

	GENERAL DEMO NOTES
ACCEPT NEV ARCHITECTU	LL DEMOLITION CLEAN AND SAFE IN A MANNER SUITABLE TO W FINISHES AND OR SURFACES REFER TO URAL PLANS, SPECIFICATIONS AND DETAILS FOR SPECIFIC ON REGARDING APPLICATION OF NEW MATERIALS
	ET AND MAINTAIN ALL (E) BUILDING ELEMENTS AND DT SLATED FOR DEMOLITION IN AREAS NEAR OR ADJACENT ION WORK
	E PROTECTION, TEMORARY ENCLOSURES AND/OR N SYSTEMS TO CONTAIN DUST WITHIN PROTECTED WORK
ACCESS TO	NATE WORK SCHEDULE, BUILDING ACCESS, USE OF AND LOADING ZONE, STAGING AND ALL REQUIRED MEP IS WITH OWNER.
	E SHORING AS REQUIRED FOR NEW FLOOR OPENINGS OR ON TO MASONRY VENEER
F SEE MEF OF MEP EQU	P DRAWINGS FOR CAPPING, CUTTING, DEMO AND SALVAGE IIPMENT AND SYSTEMS INCLUDING LIGHTING
G SALVAGE	E ALL ZINC TRIM SIDING FOR RE-USE
	NATE SELECT MASONRY DEMO VENEER FOR INSTALLATION LUCTURAL STEEL FRAMING
I SALVAGE	E DOORS AND DOOR HARDWARE FOR REUSE BY UNH
	REMOVE TOPPING SLAB
	REMOVE FINISHED FLOOR
	REMOVE TOPPING SLAB, PROTECT WATERPROOFING
	REMOVE CONCRETE SLAB
	REMOVE FLOOR FRAMING AND CONSTRUCTION
	NO WORK THIS AREA



HOLLOWAY COMMONS RENOVATIONS 75 Main St Durham, NH 03824



MILER DVER SPEARS INC.

SI CAUMENT STREET


17.338.0939 is
17.338.0939 is
WWW.067-061 con con


Proje	ect Status:	CONSTRU DOCU	ICTION MENTS
Proje	ect No:		1329
Drav	m By:		KH
Chec	ked By:		JL
Issue	Date:	November 2	5, 2014
Issue	ns Date	Description	
		4	
Revis	sions		


DEMO UPPER TERRACE PLAN

As indicated

Drawing Number

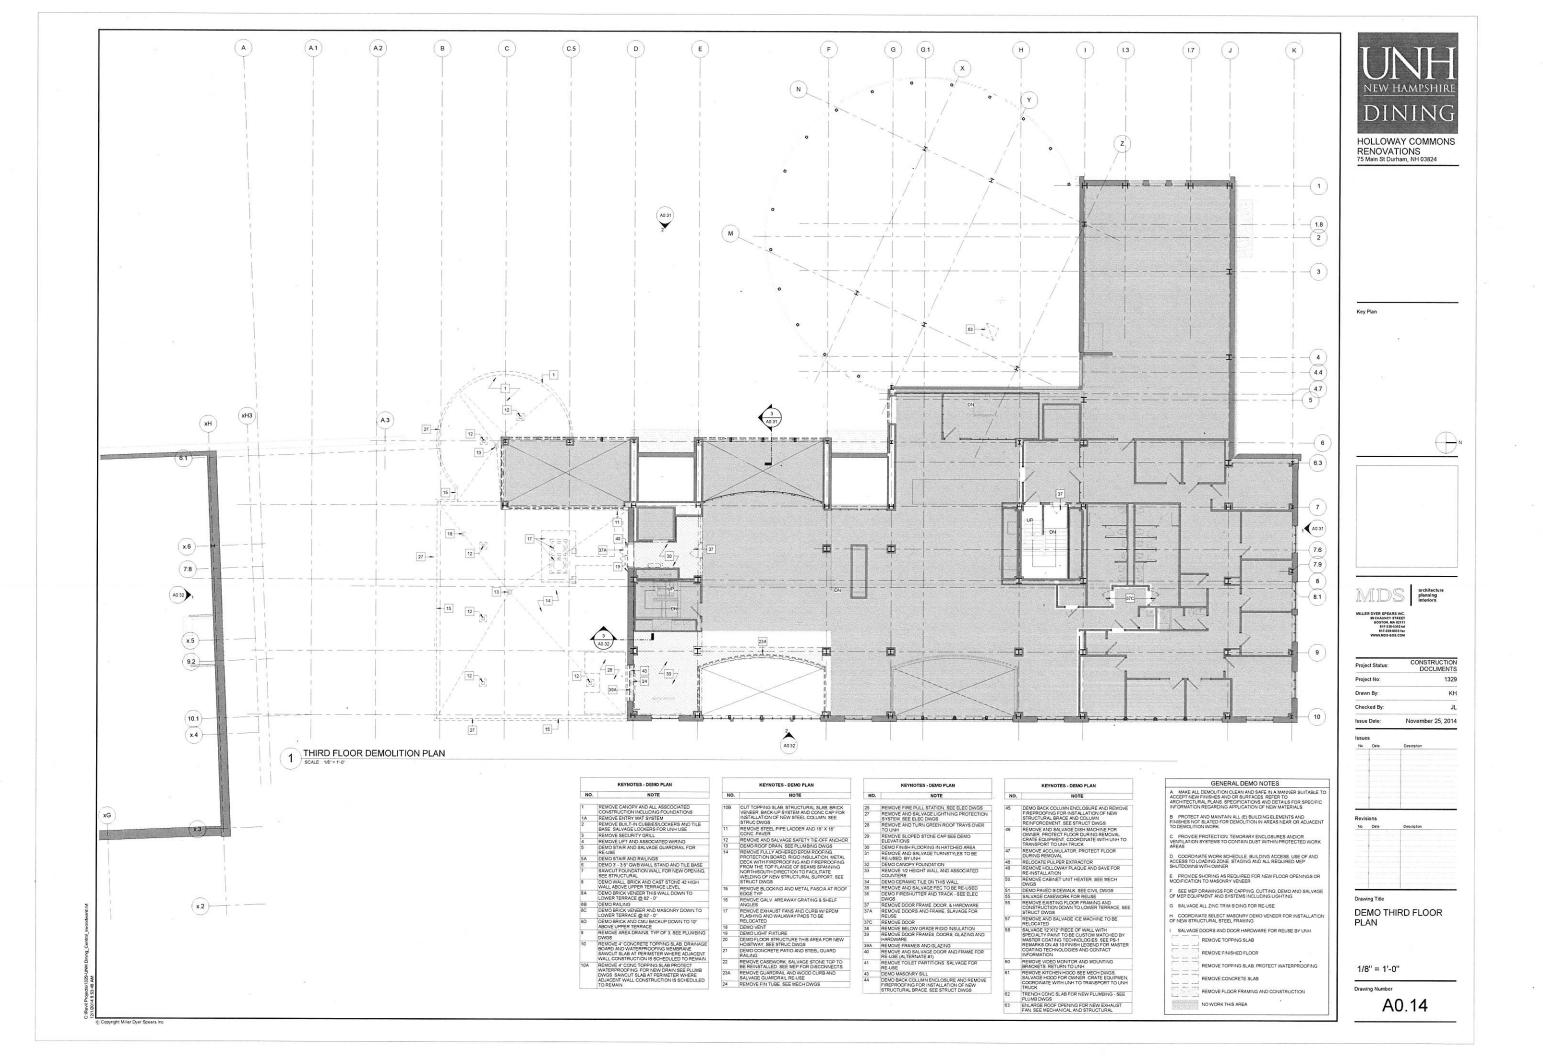


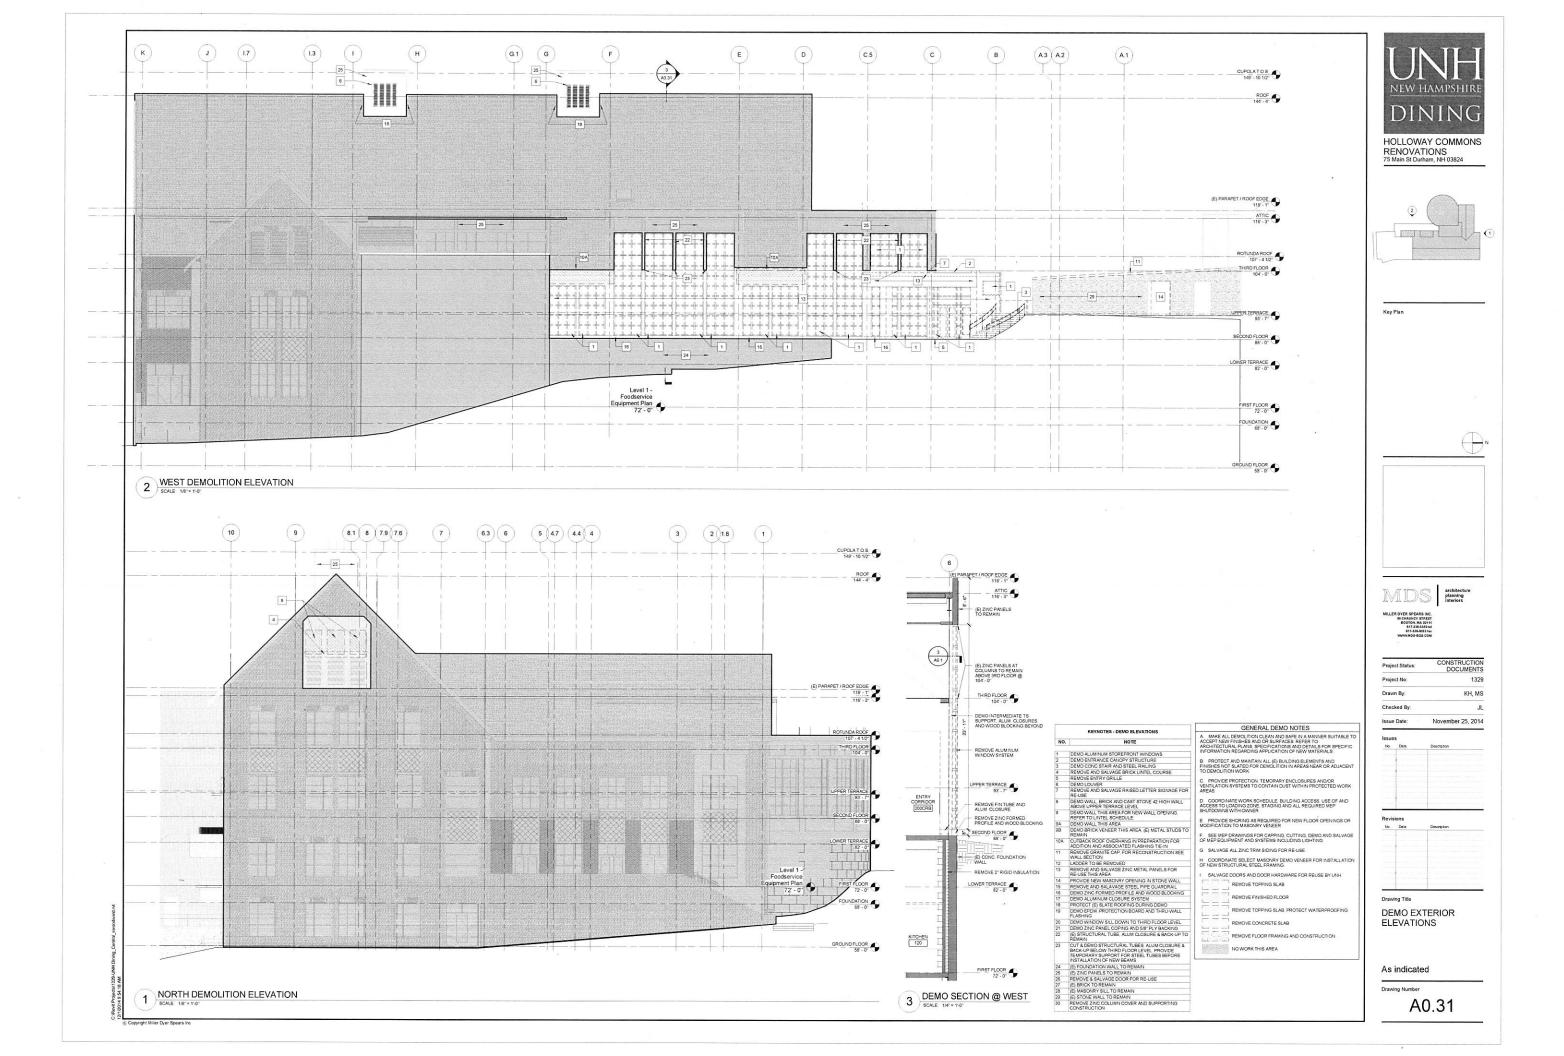

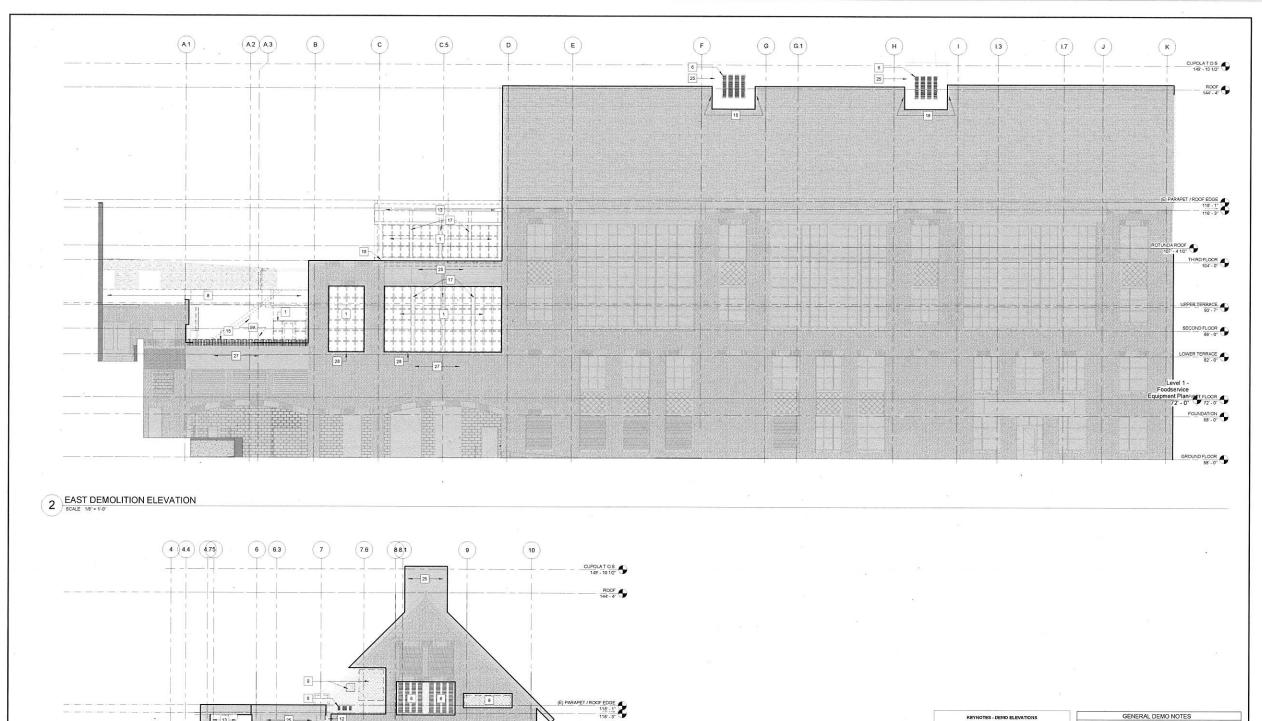

ROTUNDA ROOF 107' - 4 1/2" THIRD FLOOR

1 SOUTH DEMOLITION ELEVATION

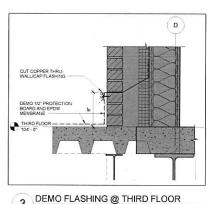


3 DEMO FLASHING @ THIRD FLOOR

	KEYNOTES - DEMO ELEVATIONS	GENERAL DEMO NOTES	
NO.	NOTE	A MAKE ALL DEMOLITION CLEAN AND SAFE IN A MANNER SUITABLE T ACCEPT NEW FINISHES AND OR SURFACES REFER TO	
		ARCHITECTURAL PLANS, SPECIFICATIONS AND DETAILS FOR SPECIFIC	
1	DEMO ALUMINUM STOREFRONT WINDOWS	INFORMATION REGARDING APPLICATION OF NEW MATERIALS	
2	DEMO ENTRANCE CANOPY STRUCTURE	B. PROTECT AND MAINTAIN ALL (E) BUILDING ELEMENTS AND	
3	DEMO CONC STAIR AND STEEL RAILING	FINISHES NOT SLATED FOR DEMOLITION IN AREAS NEAR OR ADJACENT	
4	REMOVE AND SALVAGE BRICK LINTEL COURSE	TO DEMOLITION WORK.	
5	REMOVE ENTRY GRILLE	AND THE DESIGNATION OF SECTION ASSESSMENT OF SECTION OF	
6	DEMO LOUVER	C PROVIDE PROTECTION, TEMORARY ENCLOSURES AND/OR VENTILATION SYSTEMS TO CONTAIN DUST WITHIN PROTECTED WORK AREAS	
7	REMOVE AND SALVAGE RAISED LETTER SIGNAGE FOR RE-USE		
8	DEMO WALL, BRICK AND CAST STONE 42 HIGH WALL ABOVE UPPER TERRACE LEVEL	D COORDINATE WORK SCHEDULE, BUILDING ACCESS, USE OF AND ACCESS TO LOADING ZONE STAGING AND ALL REQUIRED MEP	
9	DEMO WALL THIS AREA FOR NEW WALL OPENING, REFER TO LINTEL SCHEDULE	SHUTDOWNS WITH OWNER	
9A	DEMO WALL THIS AREA	E PROVIDE SHORING AS REQUIRED FOR NEW FLOOR OPENINGS OR	
9B	DEMO BRICK VENEER THIS AREA, (E) METAL STUDS TO REMAIN	MODIFICATION TO MASONRY VENEER F. SEE MEP DRAWINGS FOR CAPPING, CUTTING, DEMO AND SALVAGE	
10A	CUTBACK ROOF OVERHANG IN PREPARATION FOR ADDITION AND ASSOCIATED FLASHING TIE-IN	OF MEP EQUIPMENT AND SYSTEMS INCLUDING LIGHTING.	
11	REMOVE GRANITE CAP, FOR RECONSTRUCTION SEE WALL SECTION	G SALVAGE ALL ZINC TRIM SIDING FOR RE-USE	
12	LADDER TO BE REMOVED	H COORDINATE SELECT MASONRY DEMO VENEER FOR INSTALLATION	
13	REMOVE AND SALVAGE ZINC METAL PANELS FOR RE-USE THIS AREA	OF NEW STRUCTURAL STEEL FRAMING	
14	PROVIDE NEW MASONRY OPENING IN STONE WALL	I SALVAGE DOORS AND DOOR HARDWARE FOR REUSE BY UNH	
15	REMOVE AND SALAVAGE STEEL PIPE GUARDRAIL	REMOVE TOPPING SLAB	
16	DEMO ZINC FORMED PROFILE AND WOOD BLOCKING		
17	DEMO ALUMINUM CLOSURE SYSTEM	REMOVE FINISHED FLOOR	
18	PROTECT (E) SLATE ROOFING DURING DEMO		
19	DEMO EPOM, PROTECTION BOARD AND THRU-WALL FLASHING	REMOVE TOPPING SLAB, PROTECT WATERPROOFING	
20	DEMO WINDOW SILL DOWN TO THIRD FLOOR LEVEL		
21	DEMO ZING PANEL COPING AND 5/8" PLY BACKING	REMOVE CONCRETE SLAB	
22	(E) STRUCTURAL TUBE, ALUM CLOSURE & BACK-UP TO REMAIN	REMOVE FLOOR FRAMING AND CONSTRUCTION	
23	CUT & DEMO STRUCTURAL TUBES, ALUM CLOSURE & BACK-UP BELOW THIRD FLOOR LEVEL, PROVIDE TEMPORARY SUPPORT FOR STEEL TUBES BEFORE INSTALLATION OF NEW BEAMS	NO WORK THIS AREA	
24	(E) FOUNDATION WALL TO REMAIN		
25	(E) ZINC PANELS TO REMAIN		
26	REMOVE & SALVAGE DOOR FOR RE-USE		
27	(E) BRICK TO REMAIN		
28	(E) MASONRY SILL TO REMAIN		
29	(E) STONE WALL TO REMAIN		
30	REMOVE ZINC COLUMN COVER AND SUPPORTING CONSTRUCTION	22	



HOLLOWAY COMMONS RENOVATIONS 75 Main St Durham, NH 03824

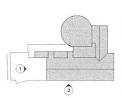

Key Plan



MDS architecture planning interiors

MILLER DYER SPEARS INC. 99 CHAUNCY STREET BOSTON, MA 02111 817-318-6359 ini 817-318-6333 fax WWW,MDS-80S.COM


Project Status: Project No: Drawn By: Checked By:		CONSTRUCTION DOCUMEN				
		13 KH, N				
			Issue	Date:	November 25, 20	
			Issues			
No	Date	Description				
		1111111				
Revisions						
No	Date	Description				
	-					
	-					
_						


Drawing Title


DEMO EXTERIOR ELEVATIONS

As indicated

Drawing Number

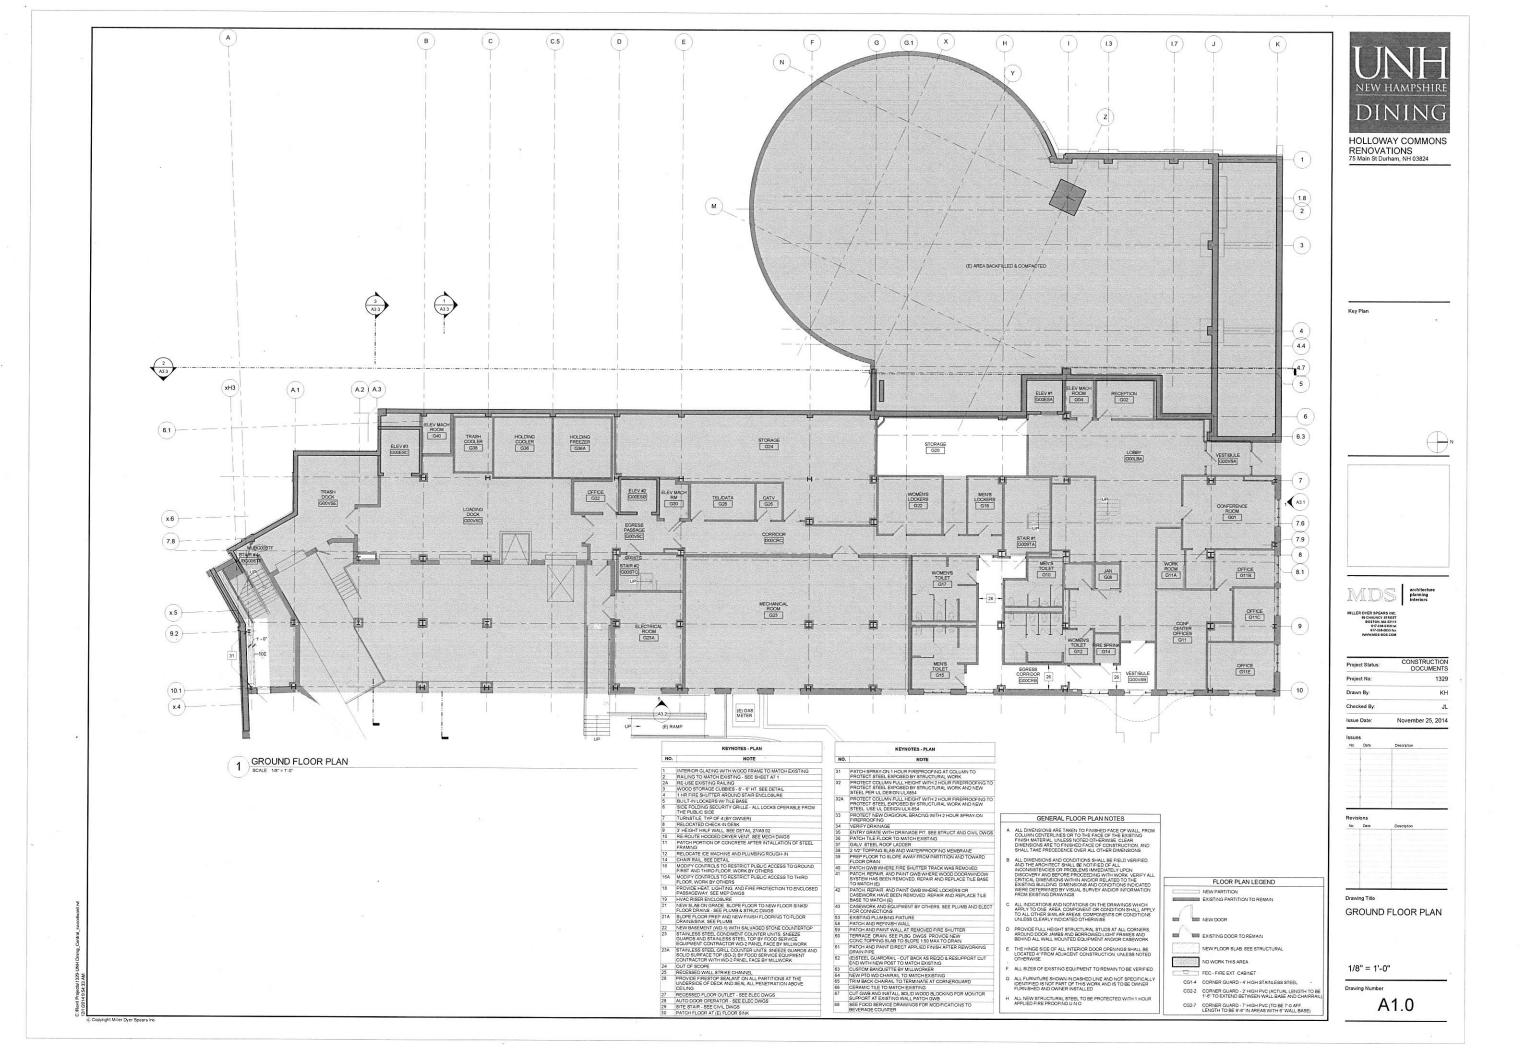


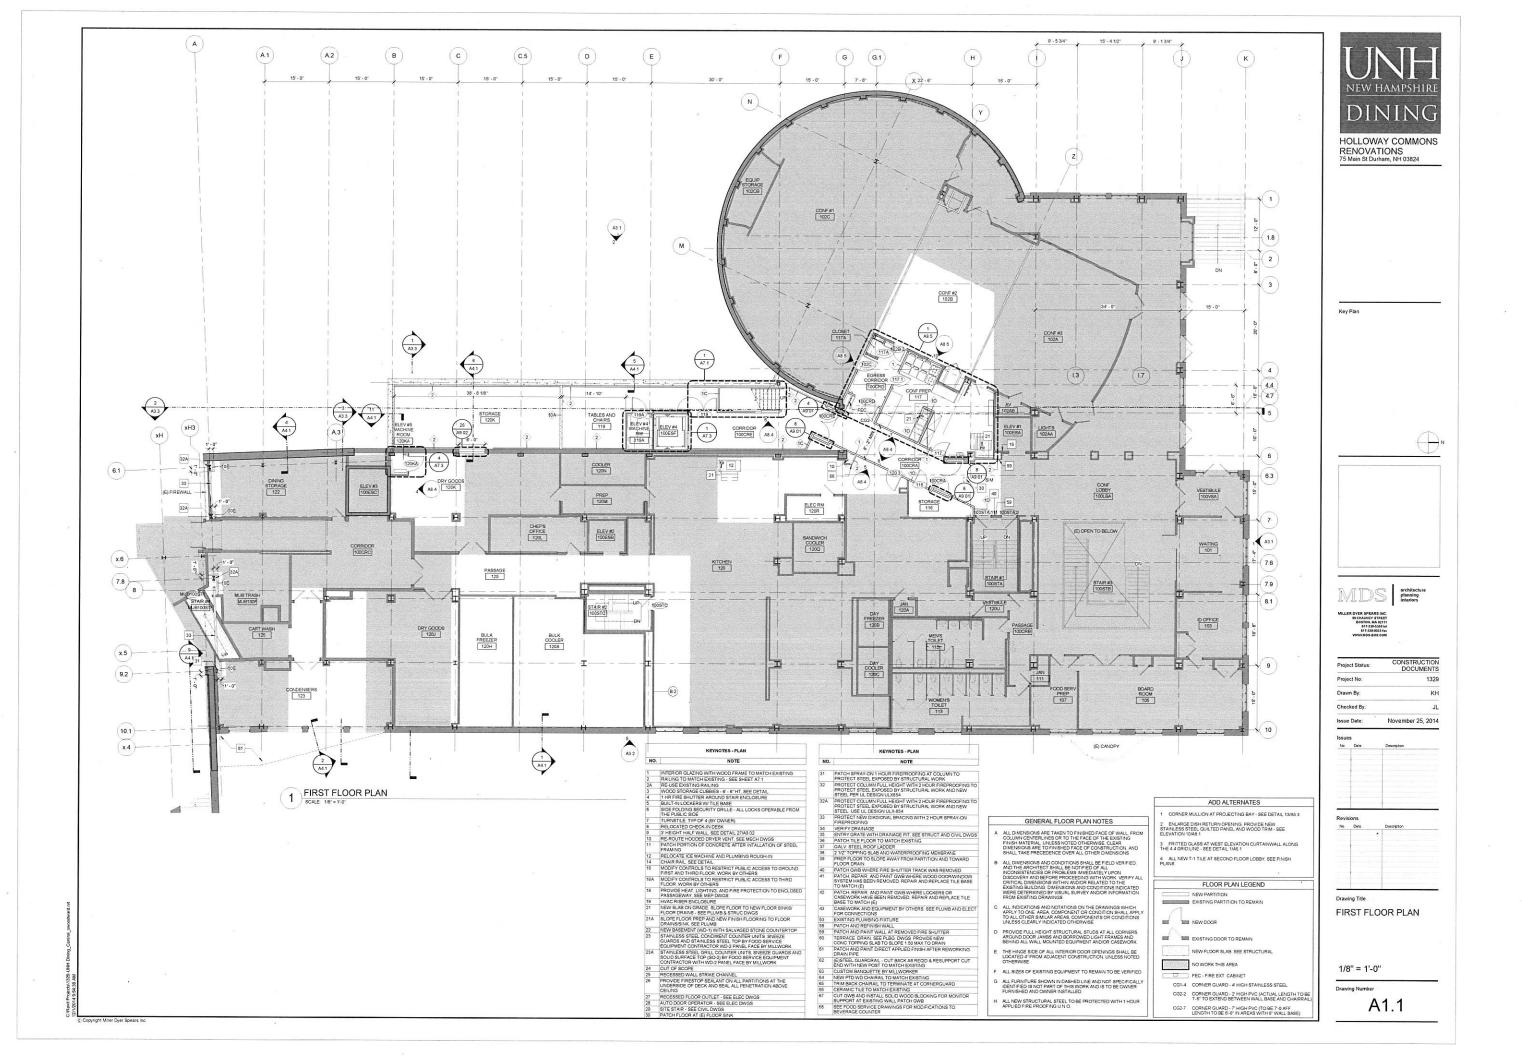

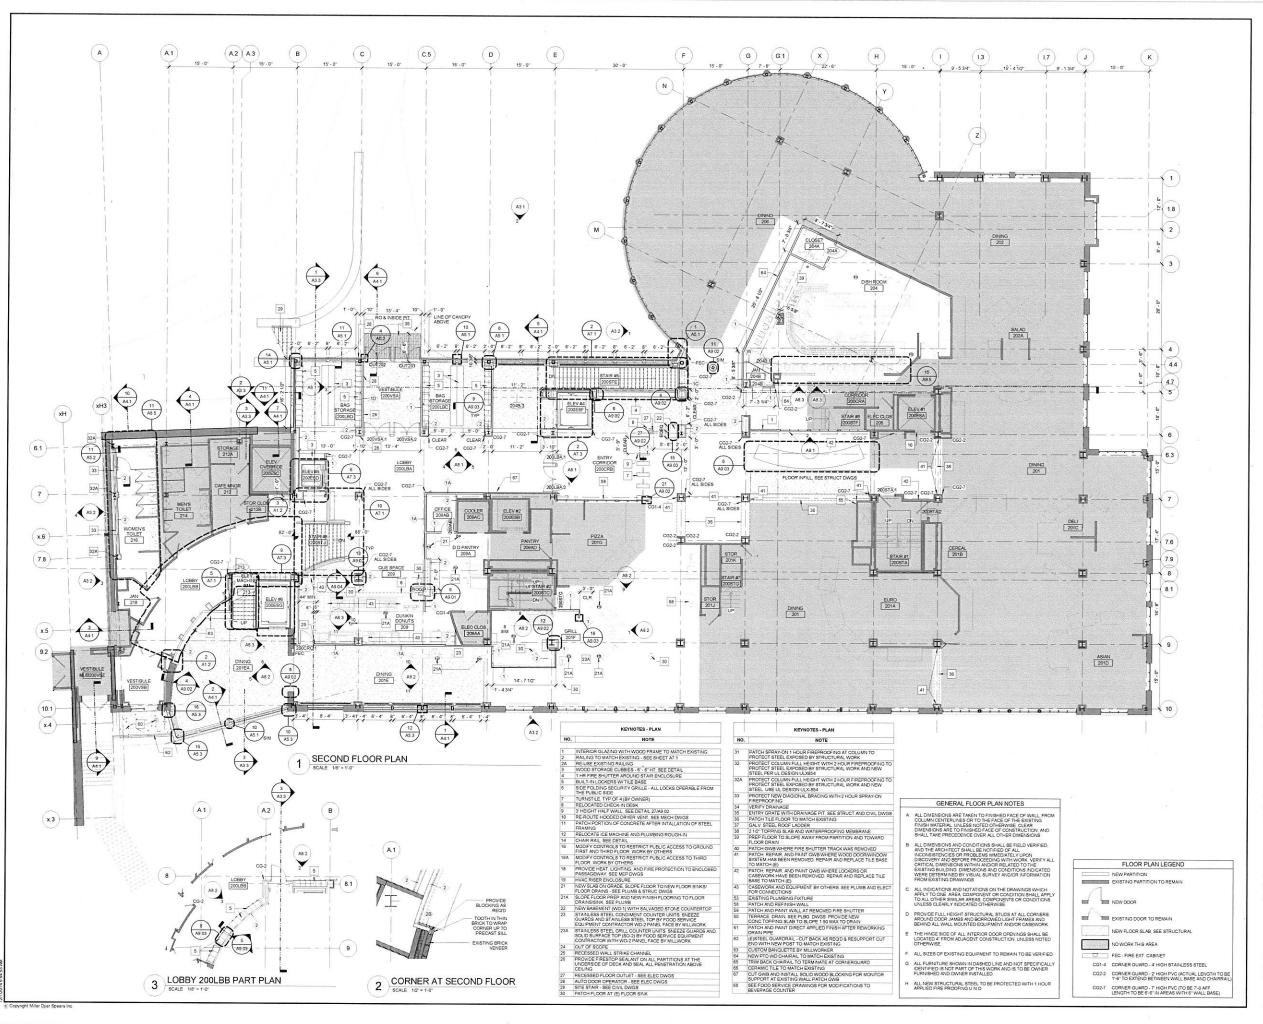



Koy Dlan

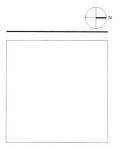

MLER OVES SPEARS INC.
9 CHANGE STREET
9 CHANGE

 Project Status:
 CONSTRUCTION DOCUMENTS

 Project No:
 1329

 Drawn By:
 KH

 Checked By:
 JL

 Issue Date:
 November 25, 2014

Revisions

No Date Description

evisions


No Dalle Description

SECOND FLOOR PLAN

As indicated

Drawing Number

A1.2

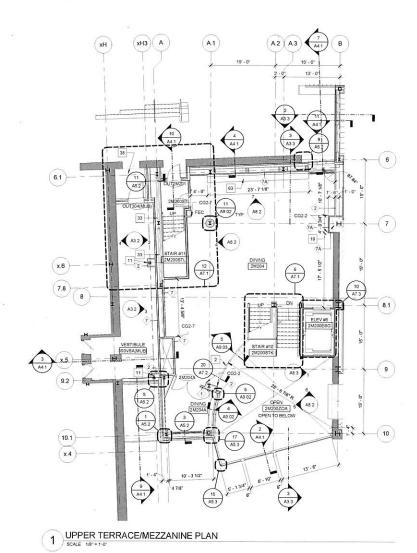

INTERIOR GLAZING WITH WOOD FRAME TO MATCH EXISTING RALING TO MATCH EXISTING SEED SHEET APT INTERIOR GLAZING WITH WOOD FRAME TO MATCH EXISTING RALING TO MATCH EXISTING SEED SHEET APT INTERIOR OF THE SEED SHEET APT INTERIOR OF THE SEED SHEET APT INTERIOR SHEET APP INTERIOR SHEET AND SHEET APP INTERIOR SHEET APP INTERI NOTE NOTE PATCH AND PANT DIRECT APPLIED FINISH AFTER REVOCKING
[RISTERL GUARGAIL, CUT BACK AS REOTO & RESUPPORT CUT
END WITH NEW POST TO MATCH EXISTING
CUSTOM BANQUETTE BY MULKYOKKER
NEW PITD WO CHARRAL TO MATCH EXISTING
TRIM BACK CHARRAL TO TERMINIST AT COCRIRERQUARD
CERANIC TILE TO MATCH EXISTING
CUT ONE AND THAT AS AS AND WOOD BECOMES FOR MONITOR
OUT ONE AND THAT AS AS AND WOOD BECOMES FOR MONITOR
OUT ONE AND THE STATEMENT OF THE MONITOR
SEE FOOD SERVICE DRAWNINGS FOR MODIFICATIONS TO
BEVERAGE COUNTER

IND.

IPATOLISPRAY ON LINUID FREEPROCEMS AT COLLIUNITO
PROTECT STEEL EXPOSED BY STRUCTURAL WORK
PROTECT STEEL EXPOSED BY STRUCTURAL WORK AND AND
FROTECT STEEL EXPOSED BY STRUCTURAL WORK AND NEW
STEEL PER LU DESIGN LUMBAY
AT STEEL PER LU DESIGN LUMBAY
STEEL PER LU DESIGN LUMBAY
STEEL USE UL DESIGN LUMBAY
FROUTET PER MAIGHT STEEL STRUCT AND CIVIL DWGS
PROTECT PER MAIGHT STEEL STRUCT AND CIVIL DWGS
PROTECT DOEN TO MAIGHT EXPOSED
STRUCT STEEL STRUCT AND CIVIL DWGS
PATON THE TOO SLOPE AND WEREPROCENING MEMBRANE
FREP PLOOR TO SLOPE AND WEREPROCED MEMBRANE
PATON THE TO SLOPE AND WEREPROCED TO MAIGHT
PATON ONE WHERE FIRE SHUTTER TRACK WAS REMOVED
PATON REPAR AND PAINT OWN WHERE WOOD DOCORWINDOW
SYSTEM HAS BEEN REMOVED REPAR AND REPLACE THE BASE
TO MAITCH (E)
CASEWORK AND EQUIPMENT BY OTHERS SEE PLUMBAND ELECT
CASEWORK AND EQUIPMENT BY OTHERS SHITTER
TERRACE DER RIBOY DATE
STEED AND THE SHIT SHITTER
TERRACE DER RIBOY DEFINES HATTER
TERRACE DER RIBOY THE SHITTER
TERRACE DER RIBOY THE SHITTER
TERRACE DER RIBOY THE SHITTER
TERRACE DER RIBOY TO SHOW TO PROVIDE THE
PATON AND REPRISH WALL
PATON AND PROVIDE THE SHITTER
TERRACE DER RIBOY TO SLOPE 150 MAY TO DRAWN
DATON AND THE OWN ONLY OF THE REPORT OR THE
BESTEEL GUARDARIL CUT BACAK AS REDO A RESUPPORT CUT
EMBUT HAT OWN OF TO THE MAIN TO PASH
DATON AND THE PATON TO SHITTER
TERRACE DER RIBOY TO SHE OWN OF THE OWN ONLY OR THE PATON TO THE TERRACE THE PROVINCING
DESIGN THE PATON TO SHE OWN OF THE OWN ONLY OR THE PATON TO THE SHE PATON TO THE SHOW TH

ALL DIMENSIONS AND CONDITIONS SHALL BE FIELD VERIFIED.

AND THE ARCHITECT SHALL BE NOTIFIED OF ALL.

FIN CONSISTINGLES OF PROCEEDING MINEDIANELY (JPCN)

INCONSISTINGLES OF PROCEEDING MINEDIANELY (JPCN)

FIN CONSISTINGLES OF AND CONDITIONS OF A CREME ALL

CRITICAL DIMENSIONS WITHIN ANDORS RELATED TO THE

EXISTING BULLONG DIMENSIONS AND CONDITIONS INDICATED

WERE DETERMINED BY VISUAL, SURVEY ANDORS INFORMATION

FROM EXISTING PRAYMOSS

GENERAL FLOOR PLAN NOTES


PROVIDE FULL HEIGHT STRUCTURAL STUDS AT ALL CORNERS AROUND DOOR JAMBS AND BORROWED LIGHT FRAMES AND BEHIND ALL WALL MOUNTED EQUIPMENT AND/OR CASEWORK

ALL SIZES OF EXISTING EQUIPMENT TO REMAIN TO BE VERIFIED ALL FURNITURE SHOWN IN DASHED LINE AND NOT SPECIFICALLY IDENTIFIED IS NOT PART OF THIS WORK AND IS TO BE OWNER FURNISHED AND OWNER INSTALLED.

ALL NEW STRUCTURAL STEEL TO BE PROTECTED WITH 1 HOUR APPLIED FIRE PROOFING U.N.O.



Key Plan

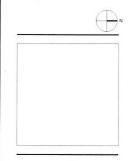

MDS architecture planning interiors MILLER DYER SPEARS INC. 99 CHAUNCY STREET BOSTON, MA 02:11 517-338-03350 tol 517-338-033 fax WWW.MDS-BOS.COM

CONSTRUCTION DOCUMENTS Project Status: 1329 Drawn By: November 25, 2014 No Date

Drawing Title UPPER TERRACE PLAN 1/8" = 1'-0"

FLOOR PLAN LEGEND

NEW FLOOR SLAB. SEE STRUCTURAL

CG1.4 CORNER GUARD - 4" HIGH STAINLESS STEEL

CG2-2 CORNER GUARD - 2' HIGH PVC (ACTUAL LENGTH TO B 1'-6" TO EXTEND BETWEEN WALL BASE AND CHAIRRA

CG2-7 CORNER GUARD - 7" HIGH PVC (TO BE 7"-0 AFF LENGTH TO BE 6"-5" IN AREAS WITH 6" WALL BASE)

NEW PARTITION

EXISTING DOOR TO REMAIN

FEC - FIRE EXT. CABINET

IIII NEW DOOR

Drawing Number

A1.3

RECESSED WALL STRIKE CHANNEL.


PROVIDE PRESSED WALL STRIKE CHANNEL.

LYCENSOL SECURITY OF SELANT ON ALL PRINTINGS AT THE UNCERSOL OF DECK AND SEA. ALL PRINTINGS AND SECURITY OF SELECTIONS.

AUTO DOOR OPERATOR. SEE ELECT DWGS.

SITE STAMS. SEE CHILD DWGS.

PATCH FLOOR AT (6) FLOOR SINK.

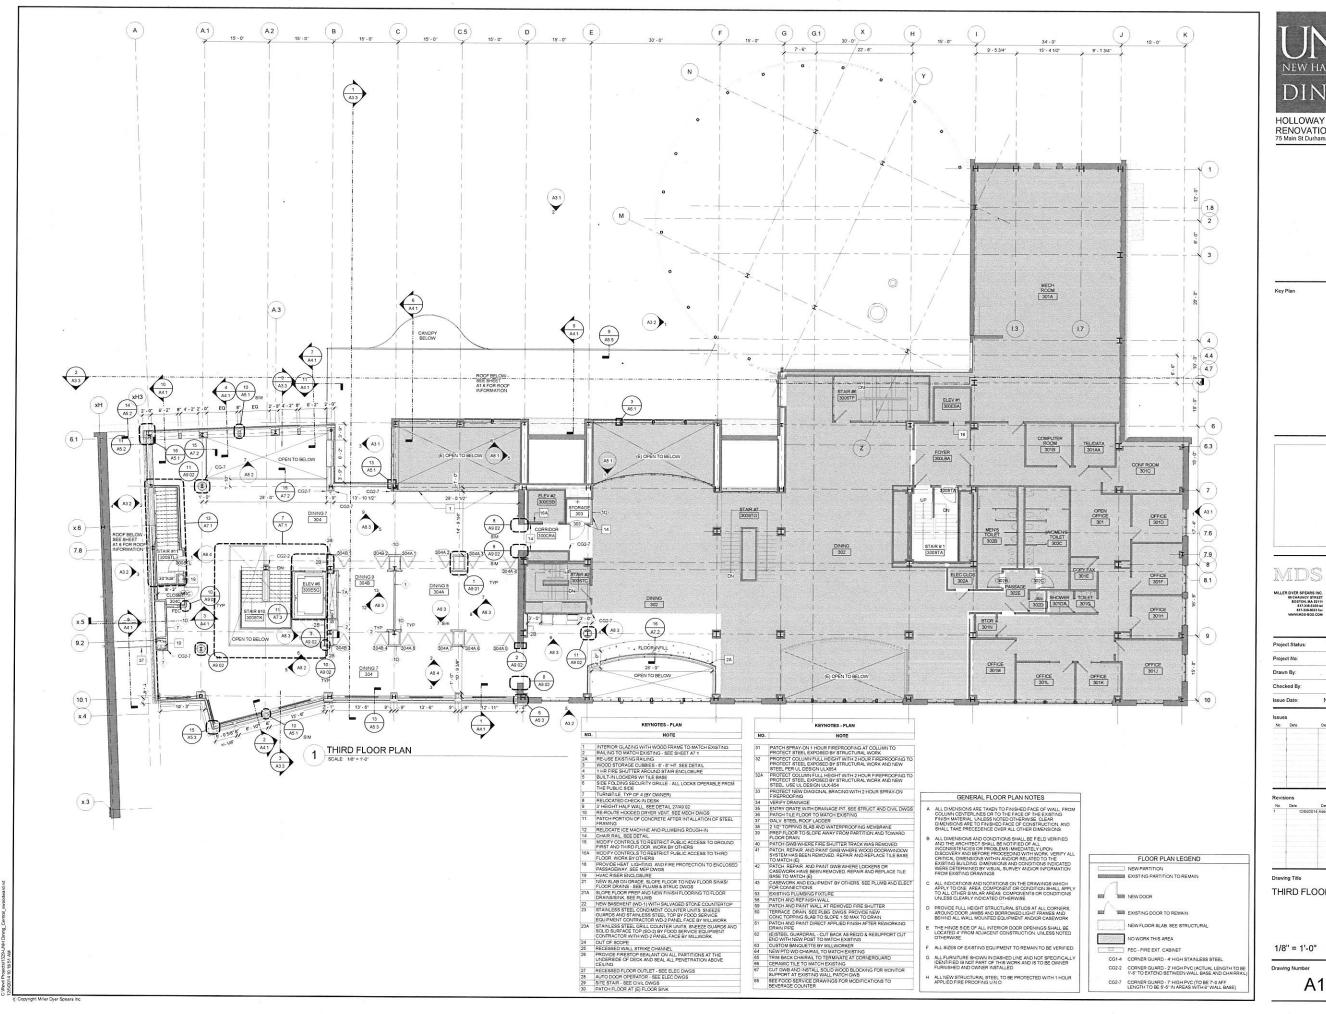

NEW HAMPSHIRI DINING

> HOLLOWAY COMMONS RENOVATIONS 75 Main St Durham, NH 03824





MDS architecture planning interiors


November 25, 2014


THIRD FLOOR PLAN


A1.4

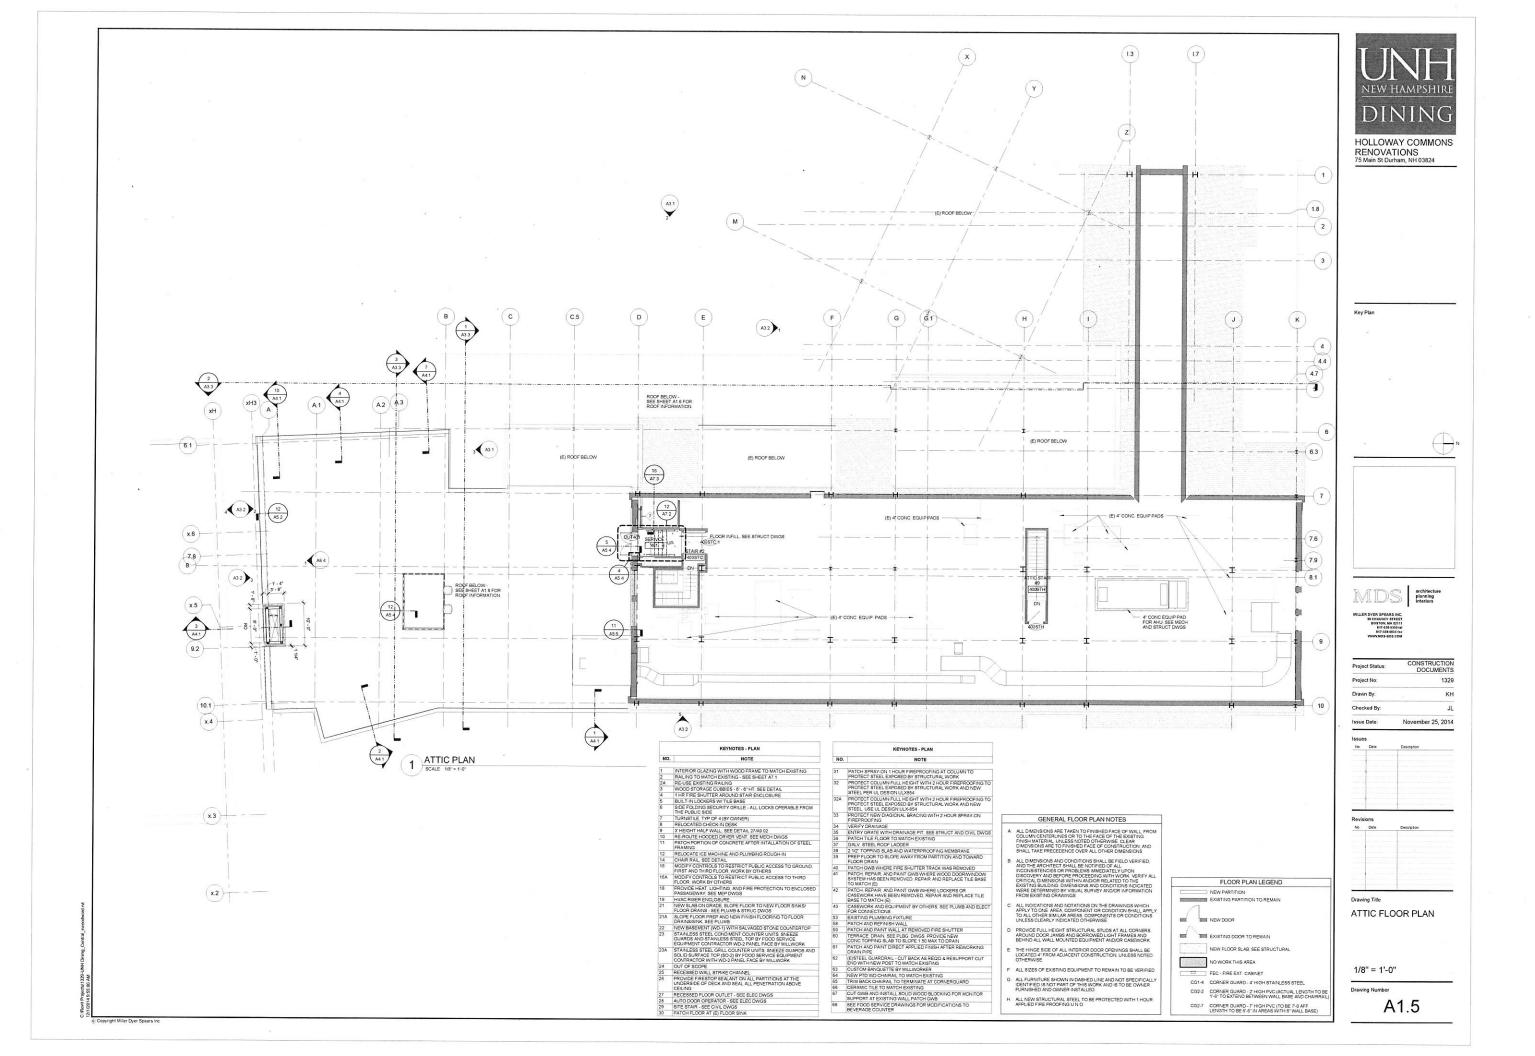


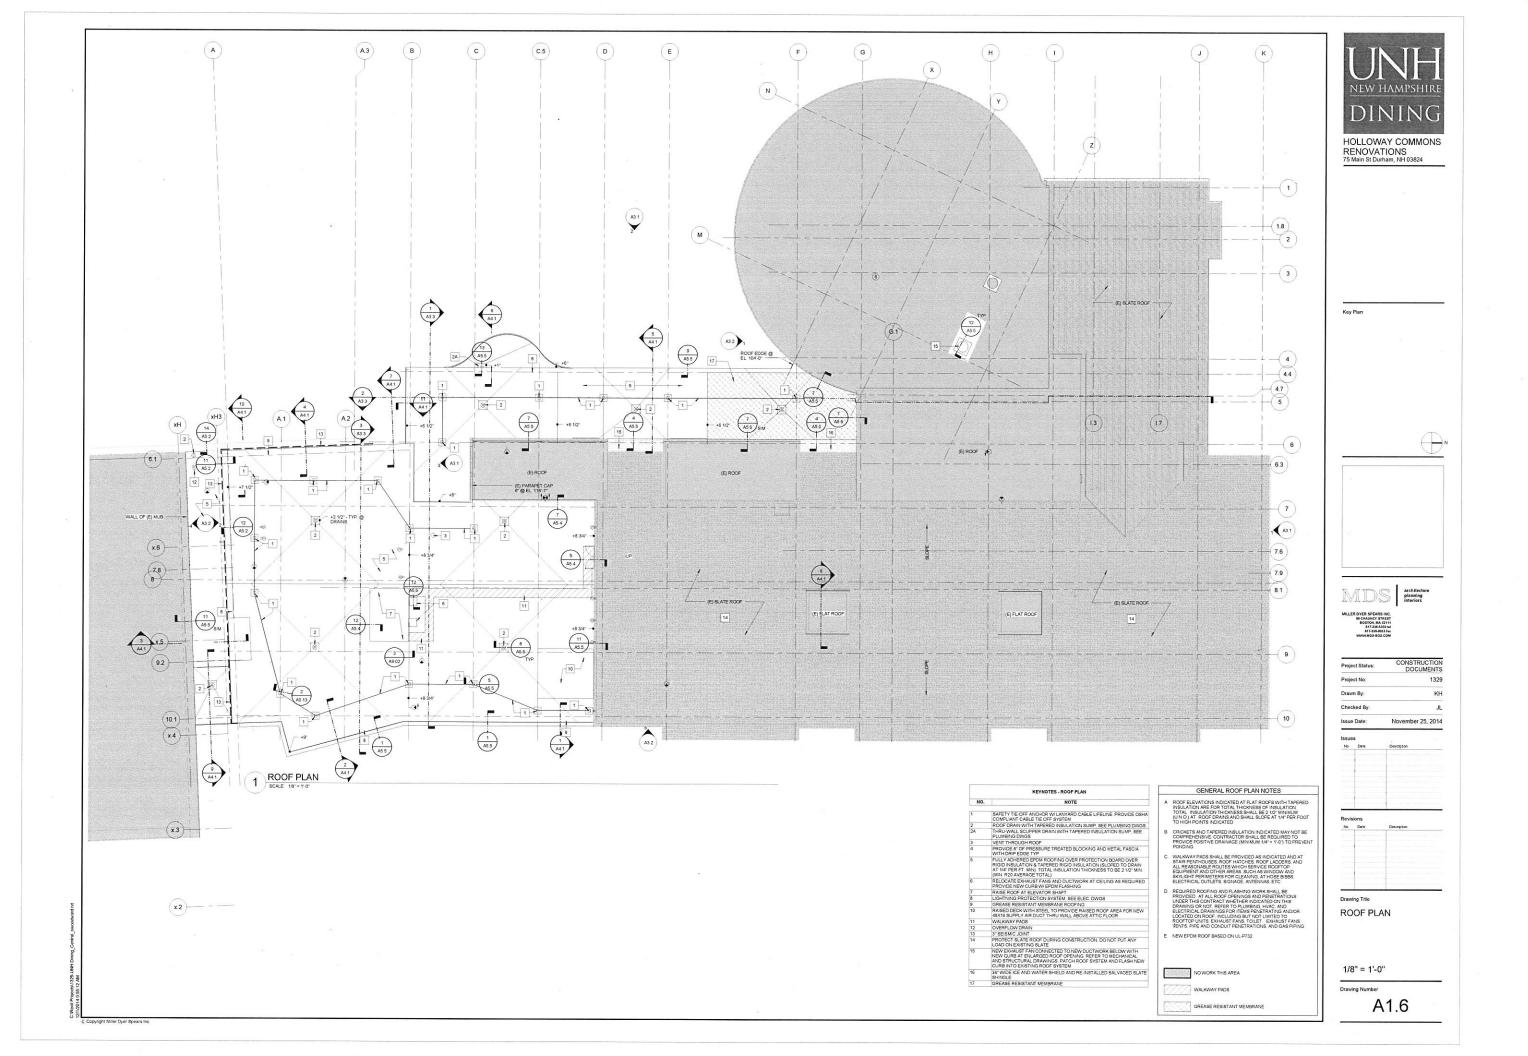

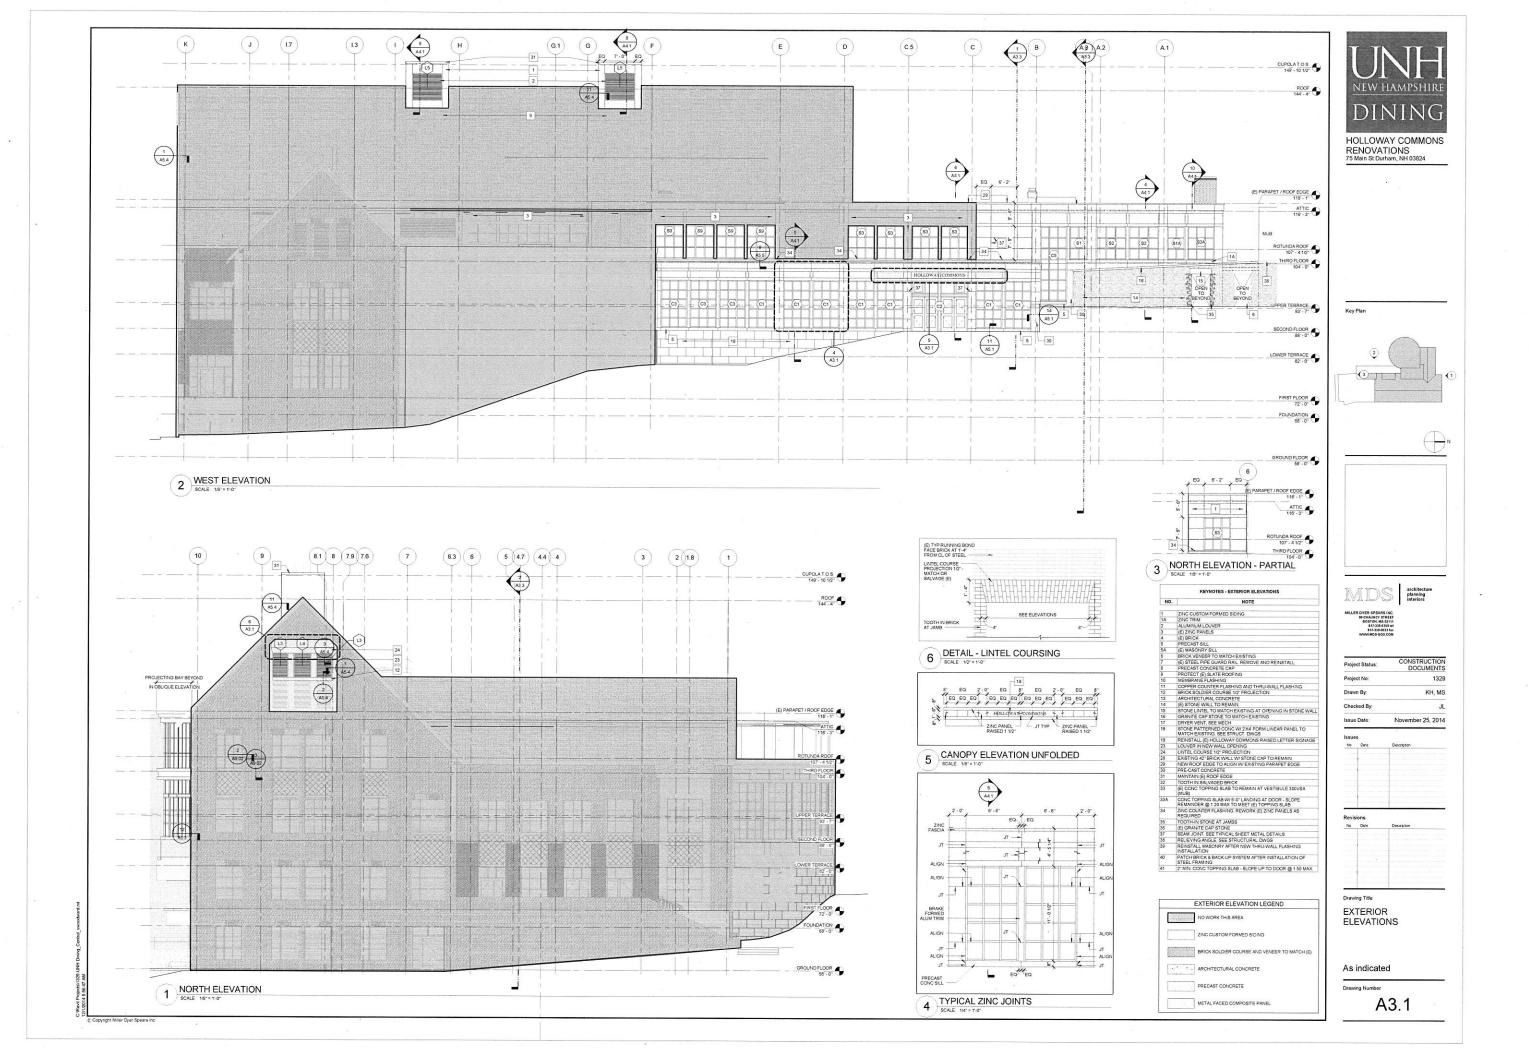

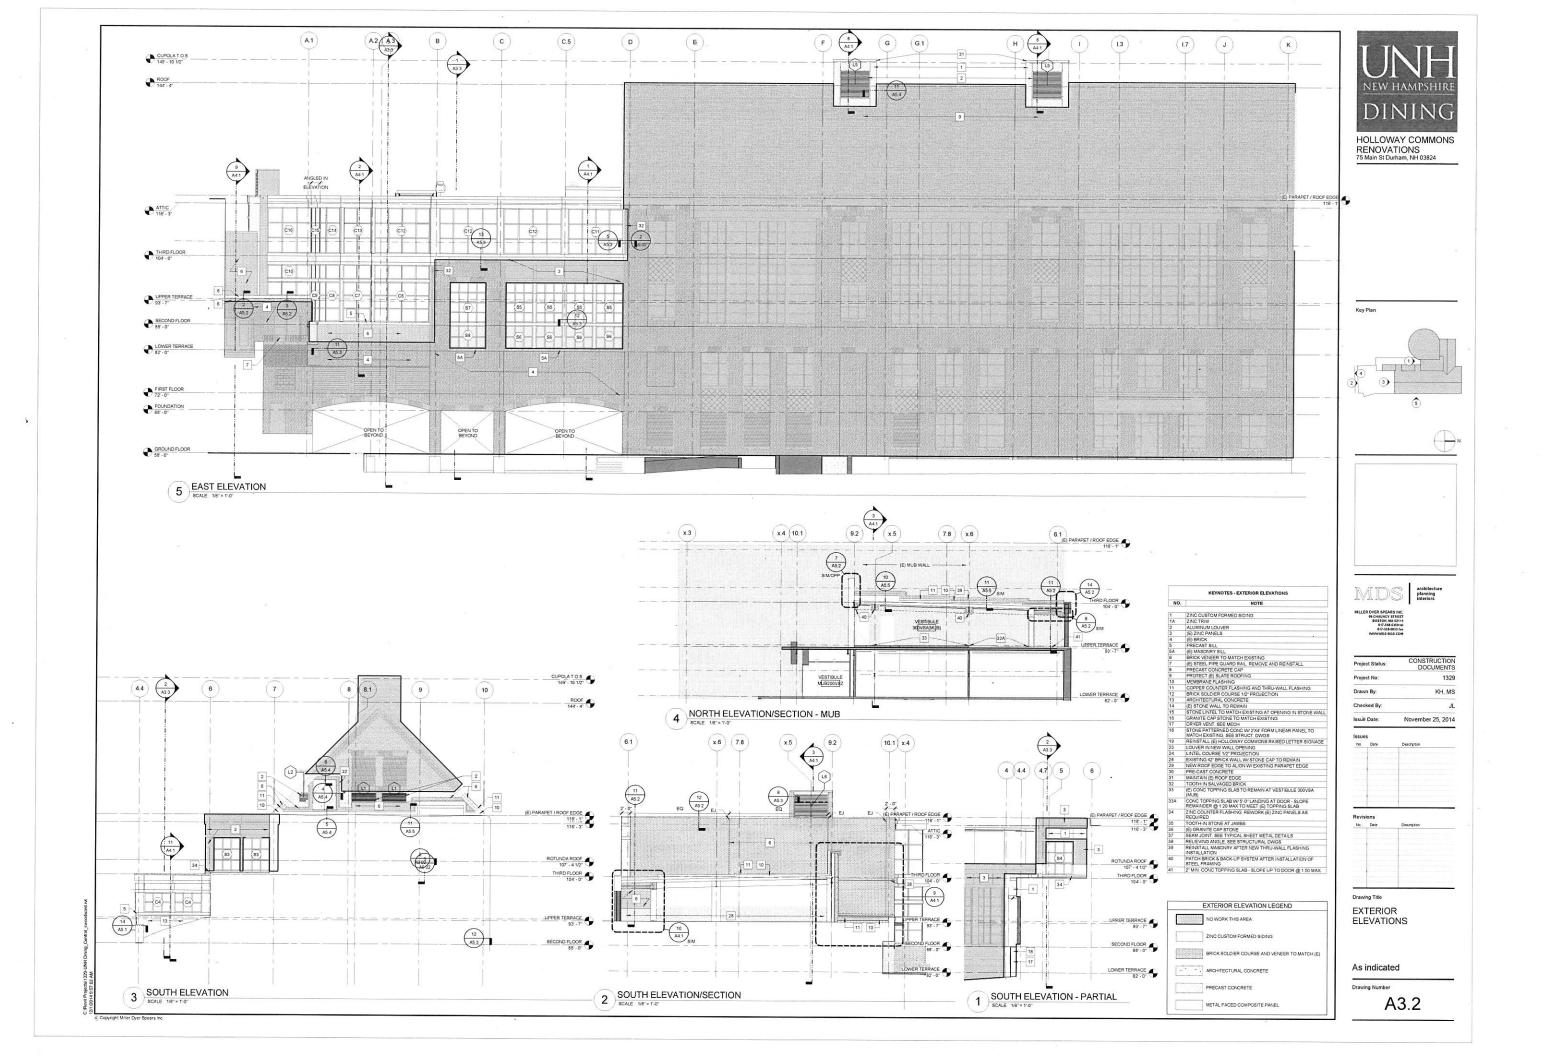

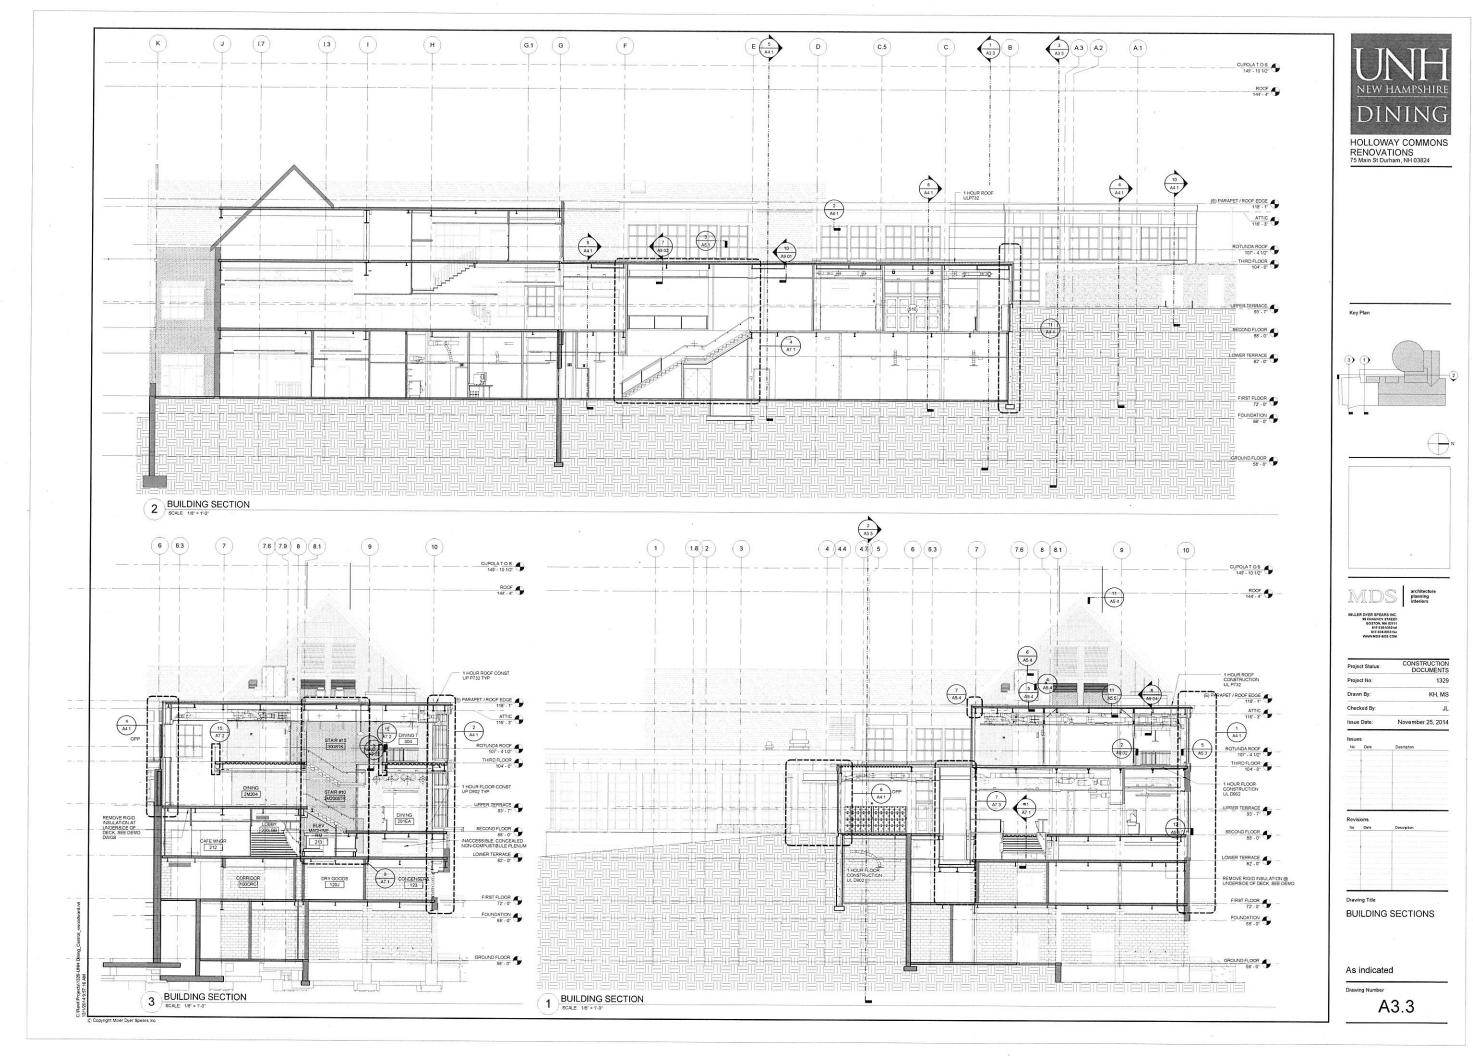

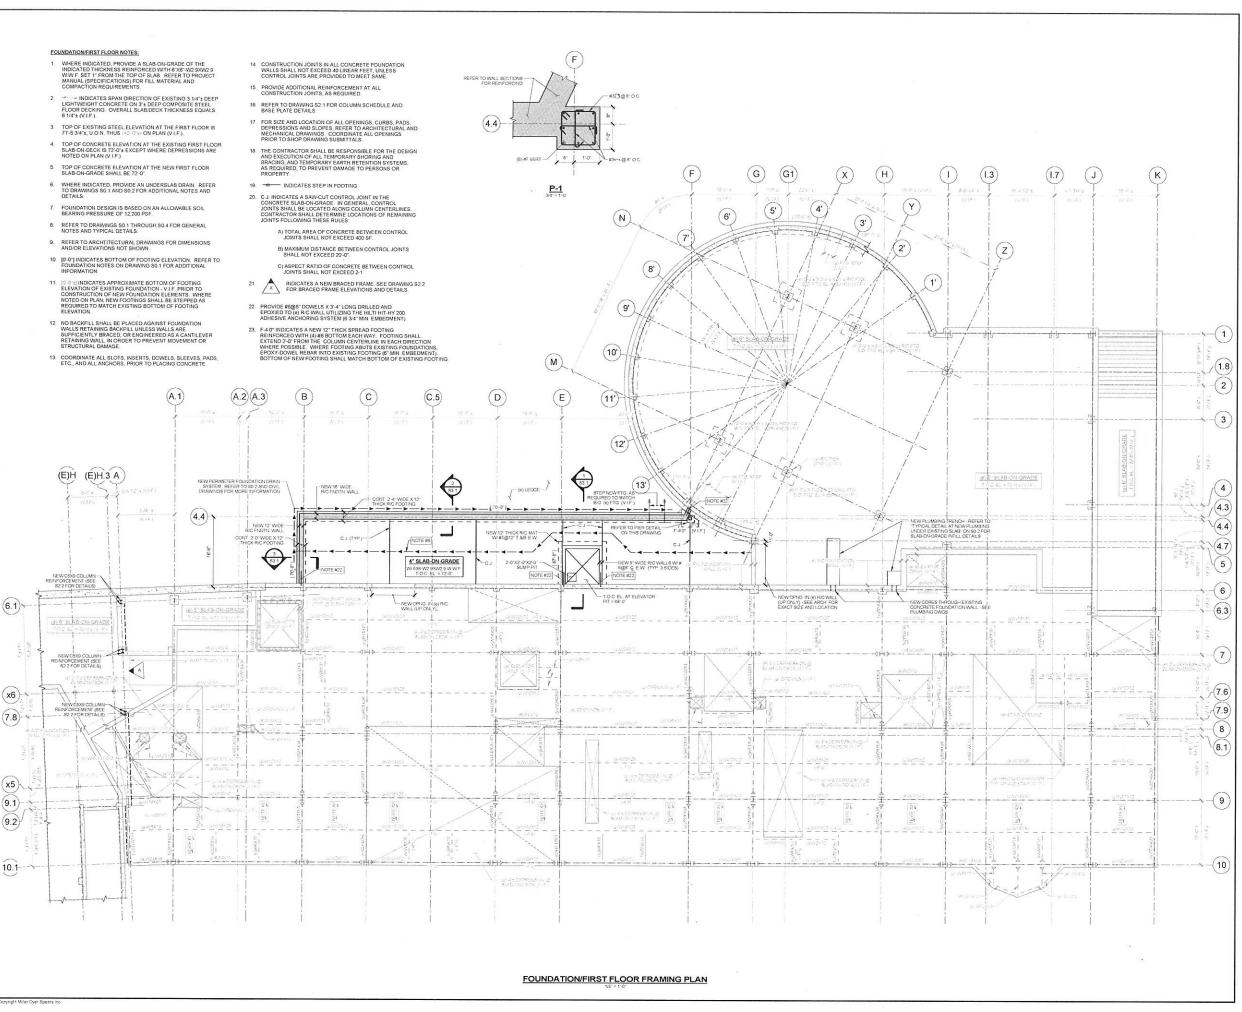

UNH NEW HAMPSHIRE DINING

HOLLOWAY COMMONS RENOVATIONS 75 Main St Durham, NH 03824



Key Plan



MILLER OVER SPEARS INC.

SPEARWHET STREET
BOSTON, MA 0911
STANSASSON
WWW.MAS AGS COM
WWW.MAS AGS COM

 Project Status:
 CONSTRUCTION DOCUMENTS

 Project No:
 1329

 Drawn By:
 MFF

 Checked By:
 JAY

 Issue Date:
 November 25, 2014

 Issues
 Description

No Dire Description

Revisions

No Dire Description

Revisions
No Date Descripton

Drawing Title

FOUNDATION/ FIRST FLOOR FRAMING PLAN

As indicated

Drawing Number

S1.2