
TWO APARTMENT BUILDINGS

257 NEWMARKET ROAD DURHAM, NEW HAMPSHIRE



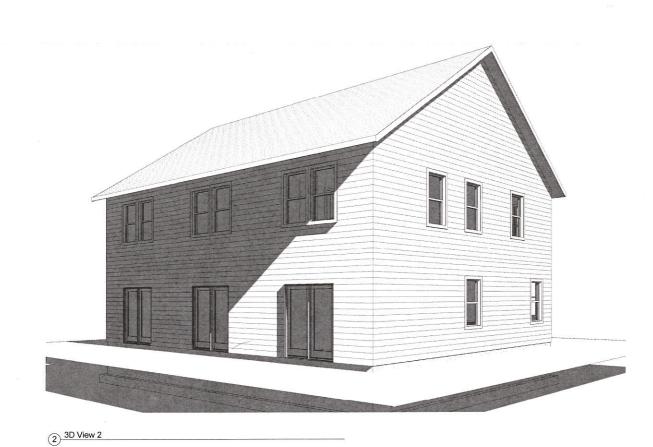

1 3D View 1

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CONTINUOL

NON-CONTINUOUS

SECTION DETAIL NO RIGID INSULATION

BATT INSULATION

A101 SHEET NO

CONCRETE MASONRY UNITS

SHEET NO

CONCRETE

FLOOR ELEVATION MARKER

///// META

Room name
101 ROOM NUM

PLYWOOD

FINISHED WOOD

PLASTER, MORTAR GROUT, ETC.

(11) ← WINDOW TYI

//// BF

YMBOLS

RECEIVED
Town of Durham
NOV 18 2014
Planning, Assessing
and Zoning

	Sheet List	
Sheet Number	Sheet Name	
A0.0	Cover	
A1.0	Basement Plan	
A1.1	First Floor Plan	
A1.2	Second Floor Plan	
A1.3	Roof Plan	
A2.0	Elevations	
A3.0	Sections	
A4.0	Wall Sections	
A5.0	Details	
C1	Site Plan	

ISAAK DESIGN, PLLC ARCHITECTURE & URBAN DESIGN

NICK@ISAAKDESIGN.COM
www.isaakdesign.com

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CONSULTANT: CONSULTANT Address Address Phone e-mail

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No. 257 Newmarket Rd.

Cover

 Project number
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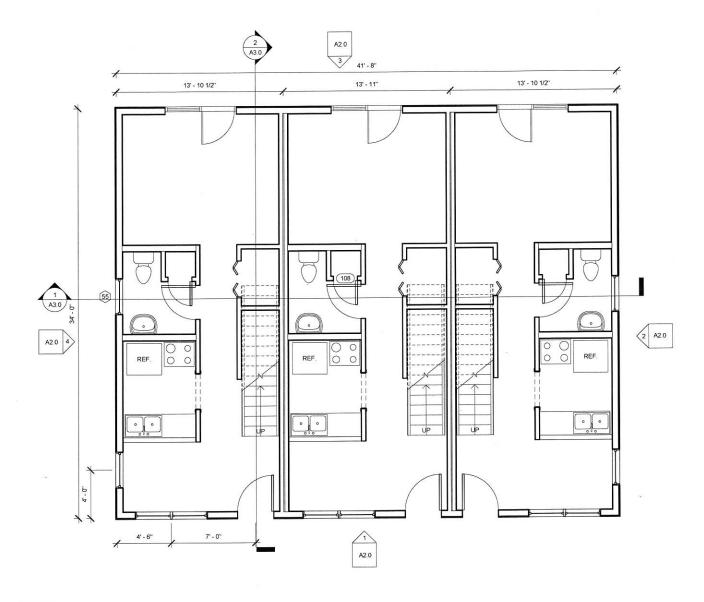
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 04/25/2014

 Drawn by
 Author

 Checked by
 Checker

A0.0

4/0" = 4! 0"



1) First Floor
1/4" = 1'-0"

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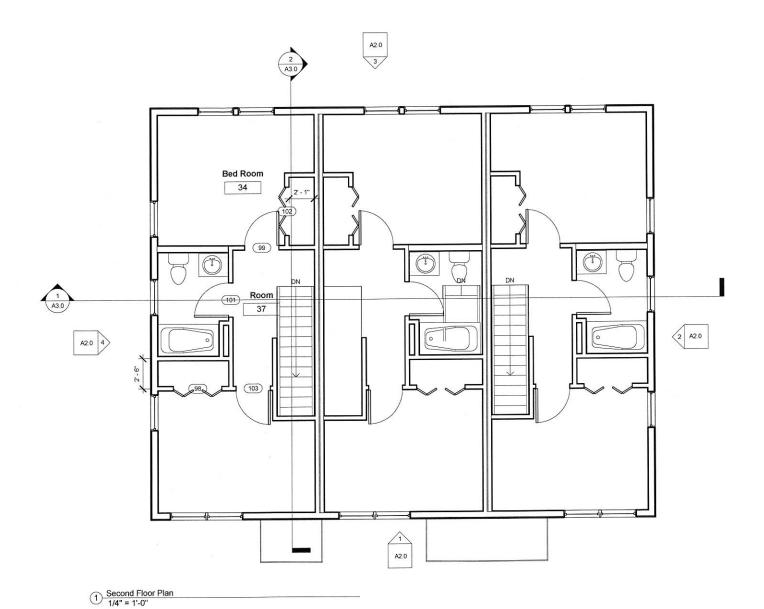
No. 257

Newmarket Rd.

First Floor Plan

A1.1

ale 1/4" = 1'-0"



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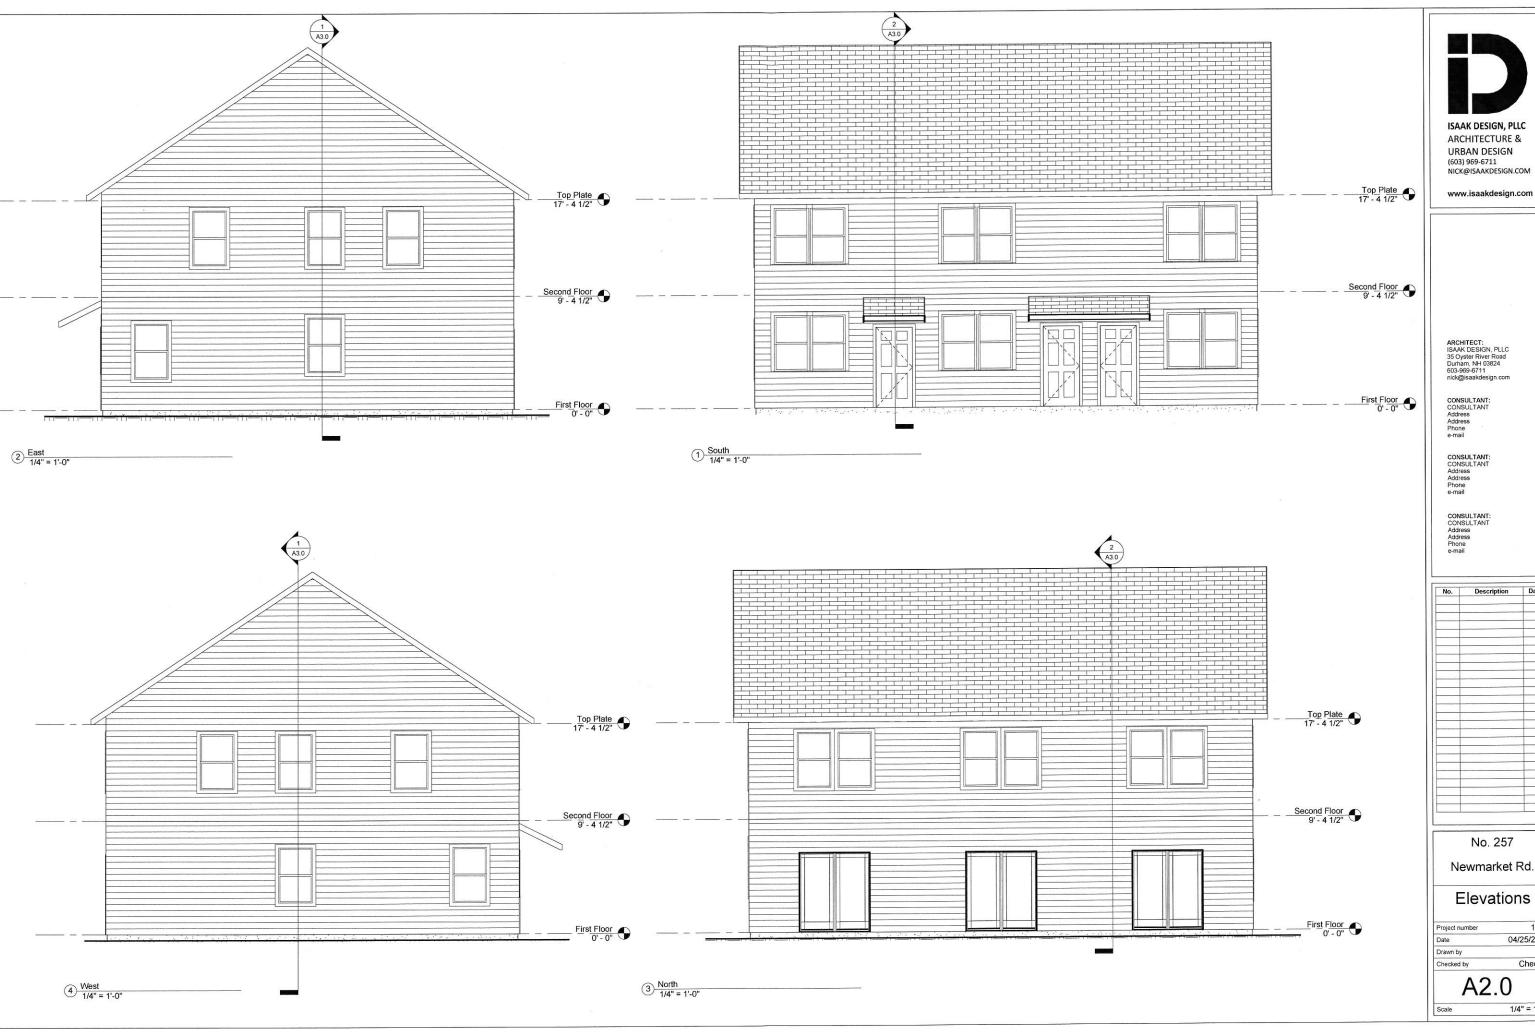
No. 257

Newmarket Rd.

Second Floor
Plan
Project number 1406
Date

A1.2

Scale 1/4" = 1'-0"



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No. 257

Elevations

1406 04/25/2014 NI


A2.0

1/4" = 1'-0"

PL1 PL1 POLE MOUNTED FIXTURE: KIM LIGHTING "ARCHETYPE" MODEL AR4/250HPS 250 WATT HIGH PRESSURE SODIUM (OR APPROVED EQUAL) 18" DIAM. X 48" CONCRETE BASE ___


3" LAYER OF ASPHALT PAVEMENT 12° CRUSHED GRAVEL PARKING CROSS SECTION N.T.S.

EXTERIOR LIGHTING FIXTURES

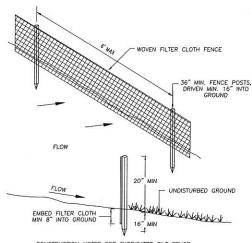

- CONSTRUCTION NOTES FOR FABRICATED SILT FENCE 1. SILT FENCE SHALL BE PLACED PRIOR TO ANY CONSTRUCTION
- 2. WOVEN FILTER CLOTH TO BE FASTENED SECURELY TO FENCE POSTS WITH WIRE TIES OR STAPLES
- WHEN TWO SECTIONS OF FILTER CLOTH ADJOIN EACH OTHER, THEY SHALL BE OVERLAPPED BY 6 INCHES AND FOLDED.
- MAINTENANCE SHALL BE PERFORMED AS NEEDED AND MATERIAL REMOVED WHEN "BULGES" DEVELOP IN THE SILT FENCE.

SILT FENCE **EROSION CONTROL DETAIL** N.T.S.

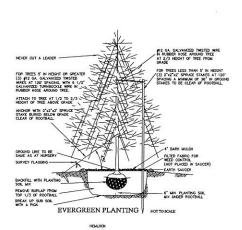





BEE BALM MEADOW SWEET CAESAR'S BROTHER IRIS BLACK EYED SUSAN FEATHER REED GRASS



SILKY DOGWOOD SPECKLED ALDER SWEET PEPPERBUSH

SHRUB PLANTING

PLANTING SCHEDULE:
3 - BIRDSFEET-TREFOL
3 - SWITCH GRASS
1 - WITCH HAZEL
1 - WINTERBERRY
PLANTS SHALL BE TRANSPLANTED FROM ELEV.=56.0 8" CONTAINERS (MINIMUM) AND SHALL BE EVENLY SPACED THROUGHOUT THE RAIN GARDEN. 0.25' HARDWOOD MULCH PONDING VOLUME 0.75 NOTES:
1. THE SOIL MEDIA SHALL
1. THE SOIL MEDIA SHALL
1. THE SUNFORM, FREE OF
SOIL STUMPS, OF
SOIL SOIL SOIL
1. ARGER THAN 2.
2. THE SAND COMPONENT
SHALL BE GRAVELLY SAND
THAT MESTS ASTM D 422.
3. THE TOPSOIL COMPONENT
SHALL BE A SANDY LOAM,
LOAMY SAND OR LOAM,
TEXTURE.
4. THE COMPOST
COMPONENT MUST BE
PROCOSSED FROM YARD
WASTE. WATER LEVEL STORM EVENT 1" STORM 2 YEAR 10 YEAR 56.04 56.74 57.13 57.24

25 YEAR 50 YEAR 100 YEAR

57.33 57.42

RAIN GARDEN DETAIL N.T.S.


- NOTES:

 VERTICAL PIPE SHALL BE 12" DIAMETER SCH 40 PVC.

 CONNECTION BETWEEN VERTICAL PIPE AND CULVERT PI SHALL BE WATER TIGHT.


 TRASH RACK SHALL BE ALUMINUM WIRE WITH 2" O.C. SPACING.

 TRASH RACK SHALL BE FIXED TO VERTICAL PIPE IN A MINIMUM OF 4 EVENLY SPACED LOCATIONS, USING ALUMINUM OF STAINLESS STEEL FASTENERS.

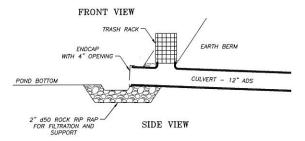

TOP OF RISER ELEV .= 57.25' 4" DIA. OPENING INVERT ELEV.=56.00

OUTLET CONTROL DETAIL N.T.S.

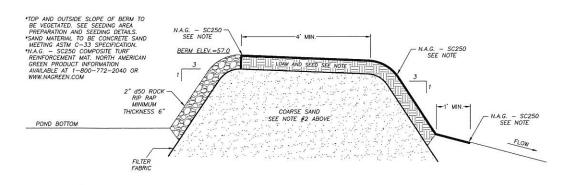

LEACHING BERM DETAIL N.T.S.

Civil Construction Management Inc. 8 Merrimac Road, Box 475 Newton, NH 03858 Tel (603) 382-7650

DETAILS

As Drawn For:

SEACOAST OPM REALTY, LLC

(Tax Map 18, Lot 3-2)


Located At:

257 Newmarket Road DURHAM, N.H.

OCTOBER, 2014

Sheet:

DATE

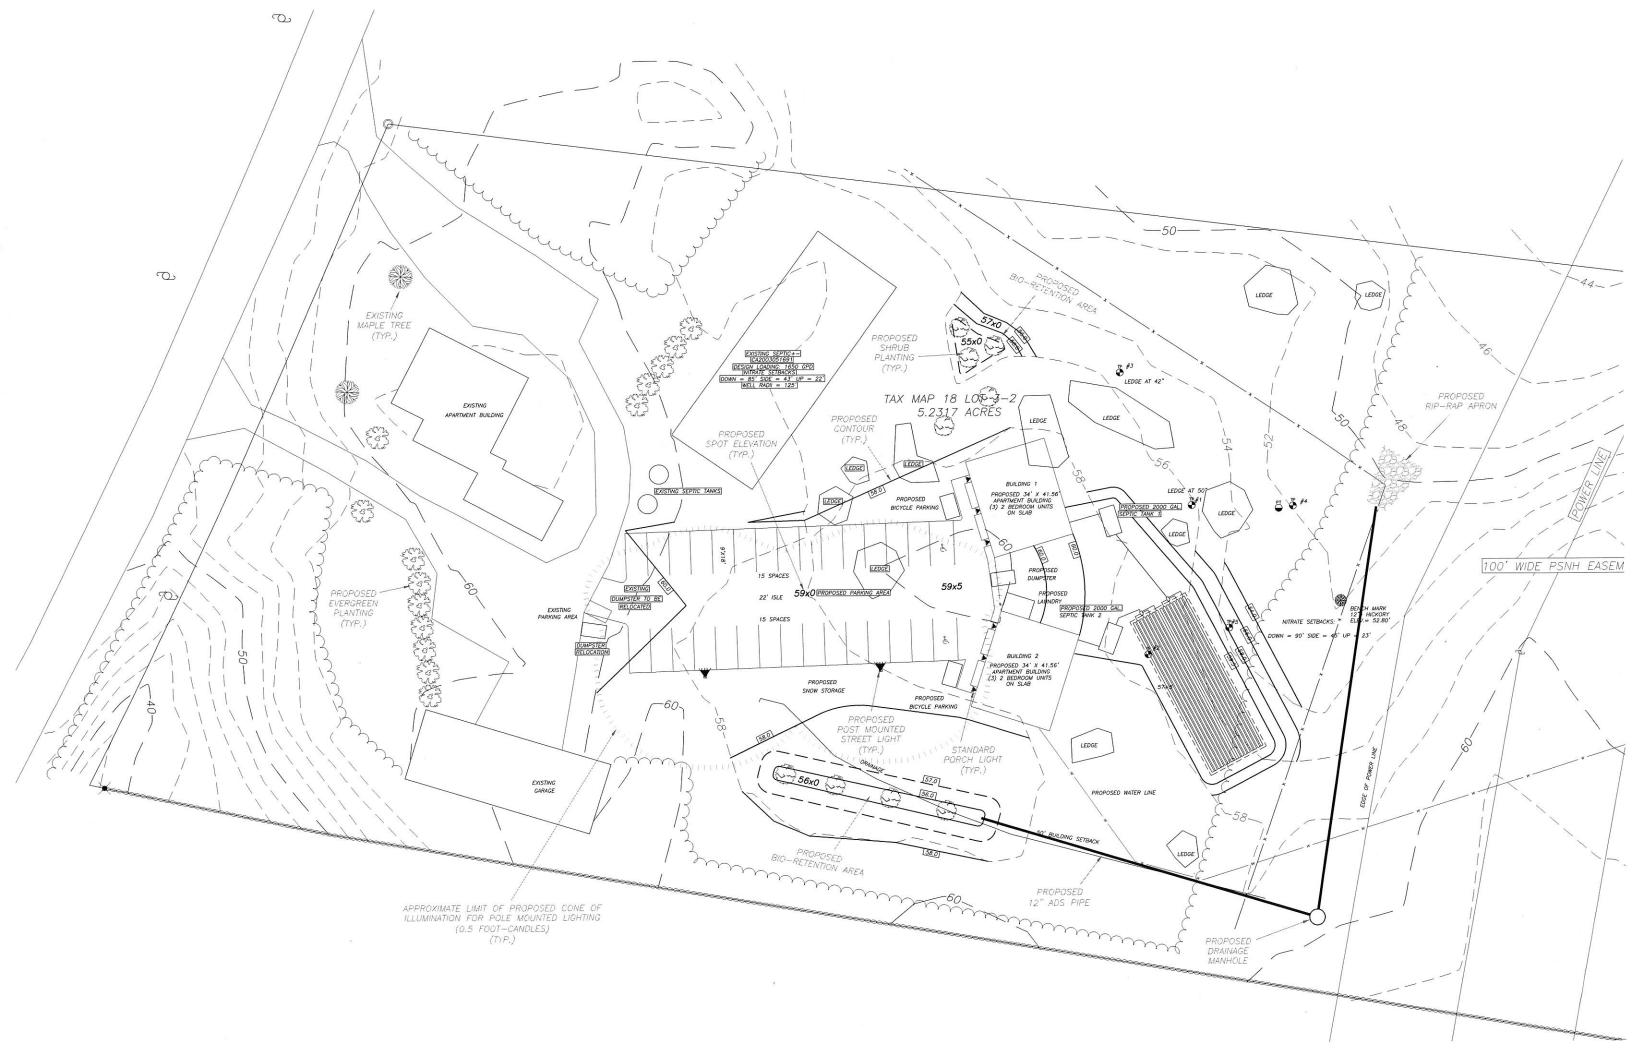



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